

MEETING OF: October 16, 2015

**CALENDAR NO.:** 270-14-BZ

PREMISES: 203 East 92<sup>nd</sup> Street, Manhattan

Block 1538, Lot 10 BIN No. 1802703

#### **ACTION OF THE BOARD – Application granted on condition.**

#### THE VOTE TO GRANT -

#### THE RESOLUTION -

**WHEREAS**, the decision of the Department of Buildings ("DOB"), dated October 22, 2014, acting on DOB Application No. 120921002, reads, in pertinent part:

ZR 32-10 Proposed Physical Culture Establishment is not permitted as-of-right in a C4-6 district as per ZR 32-10; and

**WHEREAS**, this is an application under ZR §§ 73-36 and 73-03, to permit, on a site within a C4-6 zoning district, the operation of a physical culture establishment ("PCE") within portions of a proposed mixed-use building, contrary to ZR § 32-10; and

**WHEREAS**, a public hearing was held on this application on May 19, 2015, after due notice by publication in the *City Record*, with continued hearings on June 23, 2015, July 14, 2015, August 25, 2015, and then to decision on October 16, 2015; and

**WHEREAS**, Vice Chair Hinkson, Commissioner Montanez, and Commissioner Ottley-Brown performed site and neighborhood examinations of the premises and surrounding area; and

**WHEREAS**, Community Board 8, Manhattan, recommends disapproval of this application; and

**WHEREAS**, the subject site is a through lot with 159 feet of frontage on the north side of East 92<sup>nd</sup> Street, 159 feet of frontage on the south side of East 93<sup>rd</sup> Street and a depth of 201 feet for a total of 31,958 sq. ft. of lot area; and

WHEREAS, the site is located within a C4-6 zoning district; and

**WHEREAS**, the site is currently under development with a planned 36-story mixed-use building; and

**WHEREAS**, the first through sixth floors will be occupied by a mix of residential, commercial and community facility uses, with residential use on the upper floors; and

**WHEREAS**, the proposed PCE will occupy portions of the cellar (5,511 sq. ft.), first floor (3,996 sq. ft.), fifth floor (14,014 sq. ft.) and sixth floor (14,522 sq. ft.) for a total of 32,532 sq. ft. of floor area; and

WHEREAS, the proposed PCE will be operated as Equinox; and

**WHEREAS**, the applicant states that the seventh floor (above the PCE) will be occupied by a leasing office, bicycle storage, mechanical rooms, a terrace, a residential meeting room and the building superintendent's apartment; and

**WHEREAS**, the PCE's proposed hours of operation are Monday through Saturday, from 5:30 a.m. to 11:00 p.m., and on Sunday, from 7:00 a.m. to 9:00 p.m.; and

**WHEREAS**, at hearing, the Board inquired into the sound attenuation measures in the sixth-floor ceiling; and

**WHEREAS**, the applicant responded that only low noise cardio activity will be located in the area below the superintendent's apartment and submitted a plan sheet, which reflects a hung ceiling to be fully enclosed and to include insulation material to mitigate any sound impact the PCE might have on the seventh floor; the applicant also submitted the sound consultant's notes on the expected STC ratings of the 8-inch concrete floor and the drop ceiling with gypsum board; and

**WHEREAS,** the applicant also included plans to reflect the proposed location of sound attenuation measures, including the only high activity areas on the fifth floor that would be adjacent to the proposed school on the fourth floor; and

**WHEREAS**, the Department of Investigation has performed a background check on the corporate owner and operator of the establishment and the principals thereof, and issued a report which the Board has determined to be satisfactory; and

WHEREAS, the Fire Department states that it has no objection to the proposal; and

WHEREAS, the PCE does not interfere with any pending public improvement project; and

**WHEREAS**, accordingly, the Board finds that this action will neither: (1) alter the essential character of the surrounding neighborhood; (2) impair the use or development of adjacent properties; nor (3) be detrimental to the public welfare; and

**WHEREAS**, the Board finds that, under the conditions and safeguards imposed, any hazard or disadvantage to the community at large due to the proposed special permit use is outweighed by the advantages to be derived by the community; and

**WHEREAS**, therefore, the Board has determined that the evidence in the record supports the requisite findings pursuant to ZR §§ 73-36 and 73-03; and

**WHEREAS**, the project is classified as a Unlisted Action pursuant to 6 NYCRR Part 617.2; and

WHEREAS, the site is the subject of a New York City Planning ULURP Action; and

**WHEREAS,** the site has existing institutional controls, specifically an "E designation, (E-311) relating to noise as identified in the August 21, 2013 Negative Declaration CEQR No. 13DCP121M; and

WHEREAS, the text of the 'E designation states as follows: In order to ensure an acceptable interior noise environment, future school/residential/commercial uses must provide a closed window condition with up to 41dBA of window/wall attenuation in order to maintain an interior noise level of 45 dBA. In order to maintain a closed window condition, alternate means of ventilation that brings outside air into the building without degrading the acoustical performance of the building must also be provided. Alternate means of ventilation includes, but not limited to, central air conditioning. The specific attenuation requirements to be implemented throughout the project building facades are provided in the 203-205 East 92<sup>nd</sup> Street Technical Memorandum .Table 6 (CEQR No. 13DCP121M), August 2013; and

**WHEREAS,** no other significant effects upon the environment that would require an Environmental Impact Statement are foreseeable; and

**WHEREAS**, the Board finds that, under the conditions and safeguards imposed, any hazard or disadvantage to the community at large due to the proposed special permit use is outweighed by the advantages to be derived by the community; and

Therefore it is Resolved, that the Board of Standards and Appeals adopts the Negative Declaration determination issued by the New York City Department of City Planning on August 21, 2013 for CEQR No. 13DCP121M as prepared in accordance with Article 8 of the New York State Environmental Conservation Law and 6 NYCRR Part 617 and § 6-07(b) of the Rules of Procedure for City Environmental Quality Review and Executive Order No. 91 of 1977, as amended, and makes each and every one of the required findings under ZR §§ 73-36 and 73-03, to permit, on a site within a C4-6 zoning district, the operation of a PCE on portions of the cellar, first floor, fifth floor and sixth floor of a new 36-story mixed-use building, contrary to ZR § 32-10; on condition that all work will substantially conform to drawings filed with this application marked "July 2, 2015"-(18) sheets; on further condition:

**THAT** the term of the PCE grant will expire on October 16, 2025;

**THAT** there will be no change in ownership or operating control of the PCE without prior application to and approval from the Board;

**THAT** all signage displayed at the site by the applicant shall conform to applicable regulations;

**THAT** the hours of operation will be limited to Monday through Saturday, from 5:30 a.m. to 11:00 p.m., and on Sunday, from 7:00 a.m. to 9:00 p.m.;

**THAT** the above conditions will appear on the Certificate of Occupancy;

**THAT** accessibility compliance will be as reviewed and approved by DOB;

**THAT** fire safety measures will be installed and/or maintained as shown on the Board-approved plans;

**THAT** this approval is limited to the relief granted by the Board in response to specifically cited objection(s);

**THAT** the approved plans will be considered approved only for the portions related to the specific relief granted; and

**THAT** DOB must ensure compliance with all of the applicable provisions of the Zoning Resolution, the Administrative Code, and any other relevant laws under its jurisdiction irrespective of plan(s)/configuration(s) not related to the relief granted.

Adopted by the Board of Standards and Appeals, October 16, 2015.

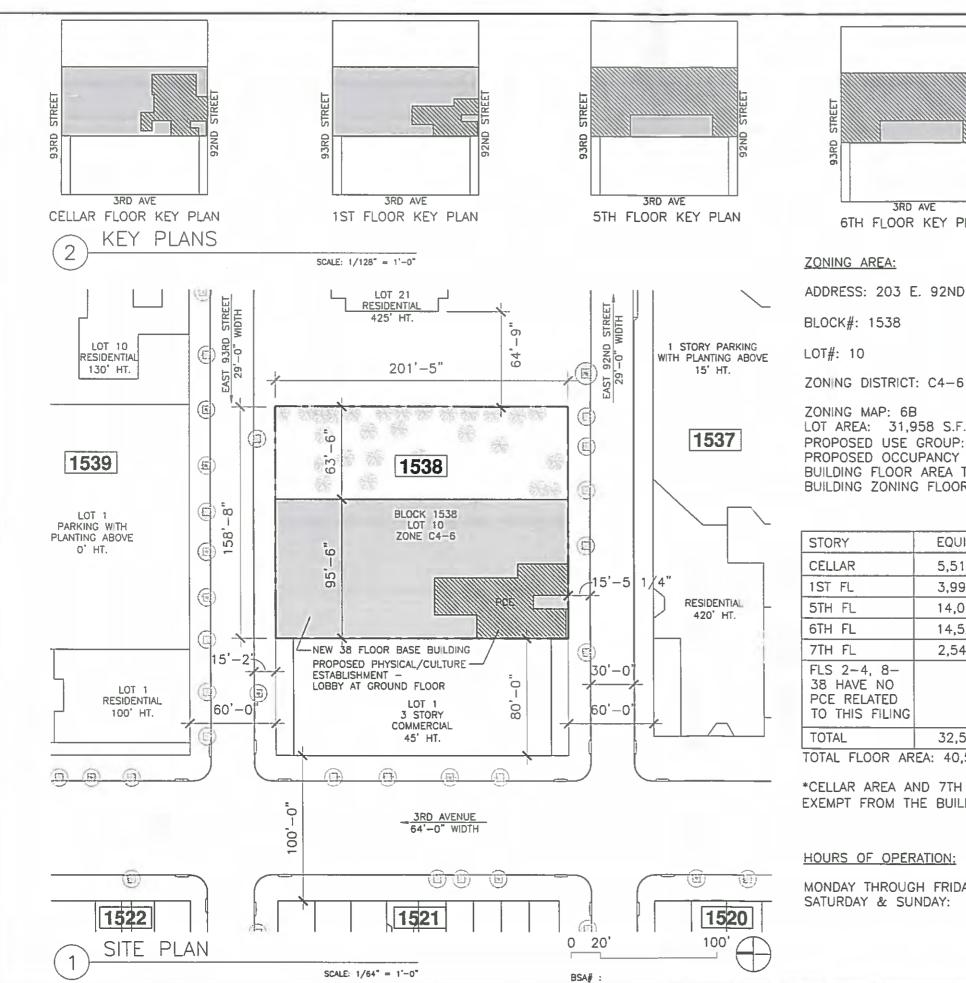
#### **CERTIFICATION**

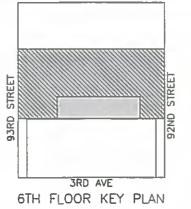
This copy of the Resolution

<u>dated October 16, 2015</u>

is hereby filed by
the Board of Standards and Appeals
<u>dated December 2, 2015</u>

Ryan Singer Executive Director





3RD AVE 7TH FLOOR KEY PLAN

#### **Platt Byard Dovell White** Architects LLP

20 West 22nd Street New York, NY-10010 212.691.2440 212,633,0144 fax www.pbdw.com

## ADDRESS: 203 E. 92ND STREET

The approval of these plans is limited solely to the relief granted by the fit All plans are subject to Department of buildings review for complaints of all other applicable laws rules and regulations.

description of the BSA approval.

## APPROVED PLANS BOARD OF STANDARDS AND APPEALS

Refer to the Certified Resolution language for the scope and specific

LOT AREA: 31,958 S.F. PROPOSED USE GROUP: PCE (BSA SPECIAL PERMIT) PROPOSED OCCUPANCY GROUP: A3

BUILDING FLOOR AREA TOTAL: 466,253 SF

BUILDING ZONING FLOOR AREA TOTAL: 384,300 SF

STORY	EQUINOX	BASE BUILDING	OCCUPANCY
CELLAR	5,511 SF*	23,914 SF	92
1ST FL	3,996 SF	17,314 SF	131
5TH FL	14,014 SF	14,682 SF	242
6TH FL	14,522 SF	15,098 SF	234
7TH FL	2,546 SF*	4,652 SF	9
FLS 2-4, 8- 38 HAVE NO PCE RELATED TO THIS FILING		308,640 SF	
TOTAL	32,532 SF	384,300 SF	708

TOTAL FLOOR AREA: 40.589 SF PHYSICAL CULTURAL ESTABLISHMENT

\*CELLAR AREA AND 7TH FLOOR ARE SHOWN FOR REFERENCE AND ARE EXEMPT FROM THE BUILDING'S ZONING FLOOR AREA

#### HOURS OF OPERATION:

MONDAY THROUGH FRIDAY: 5:00AM - 11:30PM SATURDAY & SUNDAY: 7:00AM - 9:00PM



ı	Drawn by	TC
l	Checked by	JS
	Scale	AS NOTED
	Project no.	13666
ı	Date	07.02.15

#### SITE PLAN

Sheet no.

Sheet title

BSA-1

CAL NO. 270-14-BZ

The seproval of these plans is limited solely to the relief granted by the ball plans are subject to Department of conditings review for compliance all other applicable laws rules and regulations.

befor to the Certified Resolution language for the scope and special excription of the BSA approval.

ROOM NO.	ROOM NAME	FLOOR AREA	OCCUPANCY GROUP	NO. OF PERSO
C01	FUNCTIONAL TRAINING	3,511	A-3	72
C02	ELECTRICAL ROOM	94	F-2	_
C03	EMPLOYEE LOUNGE	232	A-3	15 en 65 5
C04	EMPLOYEE WC	65	_	-615
C05	SUMP PIT	53	_	- 1200
C06	LAUNDRY	394	F-2	3
C07	ATS CLOSET	25	_	-
C08	EMR	100	_	
C09	WC	48	_	( = )
C10	ELECTRICAL ROOM	80	F-2	-
C11	TESTING OFFICE	167	В	2
100	VESTIBULE	73	_	-
101	LOBBY	1,157	A-3	77
102	SHOP	450	М	15
104	LOUNGE	160	A-3	11
105	SALES	412	М	14
106	SUPPORT/OPS	277	м	9
107	GM OFFICE	67	М	2
108	AGM/MM OFFICE	90	М	3
500	CORRIDOR	1,860		-
501	LOUNGE	743	A-3	50
502	MEN'S LOCKER ROOM	593	A-3	12
502A	MEN'S STEAM ROOM	121	A-3	3
502B	MEN'S TOILET ROOM	789	A-3	-
503	SPA LOUNGE	210	В	3
503A	TREATMENT	117	A-3	2
503B	TREATMENT	120	A-3	2
504	WOMEN'S LOCKER ROOM	580	A-3	12
504A	WOMEN'S STEAM ROOM	124	A-3	3
504B	WOMEN'S TOLLET ROOM	965	A-3	_
505	GYM OFFICE	92	8	1
506	CYCLING	965	A-3	47
507	BARRE	1,207	A-3	31
508	PILATES	485	A-3	12
509	YOGA	1,345	A-3	41
510	KID'S CLUB	688	A-3_	23
600	CORRIDOR	1,023	<u> 22</u>	_
601	STRENGTH	4,876	A-3	98
602	CARDIO	3,566	A-3	89
603	GROUP FITNESS	1,584	A-3	32
604	STORAGE	270	S-2	1
605	EQUIFIT	128	В	2
606	PT	86	В	1
607	STRETCH	550	A-3_	11
701	MECHANICAL ROOM	1,406	F-2	5
702	MECHANICAL ROOM	1,072	F-2	4

## Platt Byard Dovell White Architects LLP

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Project

## EQUINOX 92ND STREET

Drawn by TC

Checked by JS

Scale 1/16"=1'-0"

Project no. 13666

Date Sheet title

## NOTES & AREA CALCULATIONS

Sheet no.

BSA-2

07.02.15

CAL NO. 270-14-BZ

#### GENERAL NOTES.

ALL INTERIOR LAYOUTS AND EXITS SHALL BE AS APPROVED BY THE DEPARTMENT OF BUILDINGS.

2, MINIMUM 3'-0" WIDE EXIT PATHWAYS SHALL BE APPROVED LEADING TO THE REQUIRED EXITS. PATHWAYS SHALL ALWAYS BE MAINTAINED UNOBSTRUCTED, INCLUDING FROM ANY GYMNASIUM EQUIPMENT.

3. AN APPROVED INTERIOR FIRE ALARM SYSTEM SHALL BE INSTALLED IN THE ENTIRE PCE SPACE. THE SYSTEM WILL INCLUDE THE FOLLOWING ITEMS:

A. AREA SMOKE DETECTORS

B. MANUAL PULL STATIONS AT EACH REQUIRED EXIT C. LOCAL AUDIBLE AND VISUAL ALARMS

CONNECTION OF THE INTERIOR FIRE ALARM TO A FDNY APPROVED CENTRAL STATION

4. LOCAL LAW 58-87 SHALL BE COMPLIED WITH AND AS APPROVED BY THE DEPARTMENT OF BUILDINGS.

5. PROPOSED SIGNAGE WILL COMPLY WITH APPLICABLE ZONING REGULATIONS.

6. FACILITY TO BE EQUIPPED WITH SPRINKLER SYSTEM - FILED UNDER A SEPARATE APPLICATION.

CELLAR FLOOR PLAN

NOISE NOTES:

1. THE BUILDING IS SUBJECT TO THE CONDITIONS CONTAINED IN THE CEOR NO. 13DCP 121M
REVISED NEGATIVE DECLARATION DATED AUGUST 21, 2013 — IN ORDER TO ENSURE AN ACCEPTABLE
INTERIOR NOISE ENVIRONMENT, FUTURE SCHOOL/RESIDENTIAL/COMMERCIAL USES MUST PROVIDE A CLOSED WINDOW CONDITION WITH UP TO 41 DBA OF WINDOW/WALL ATTENUATION IN ORDER TO MAINTAIN AN INTERIOR NOISE LEVEL OF 45 DBA\*\*. IN ORDER TO MAINTAIN A CLOSED WINDOW CONDITION, AN ALTERNATE MEANS OF VENTILATION THAT BRINGS OUTSIDE AIR INTO THE BUILDING, WITHOUT DEGRADING THE ACOUSTICAL PERFORMANCE OF THE BUILDING MUST ALSO BE PROVIDED.

ALTERNATE MEANS OF VENTILATION INCLUDES, BUT IS NOT LIMITED TO, CENTRAL AIR CONDITIONING THE SPECIFIC ATTENUATION REQUIREMENTS TO BE IMPLEMENTED THROUGH THE PROJECT BUILDING FACADES ARE PROVIDED IN THE 203-205 EAST 92ND STREET TECHNICAL MEMORANDUM, TABLE 6 (CEQR NO. 13DCP121M), AUGUST 2013.

\*\*\*PER TABLE 6 (CEOR NO. 13DCP121M), AUGUST 2013, THE SUBJECT PCE MUST PROVIDE A CLOSED WINDOW CONDITION, ON THE WEST FACADE ONLY, WITH 32 DBA ON THE 5TH FLOOR AND CLOSED WINDOW CONDITION WITH 30 DBA ON THE 6TH FLOOR IN ORDER TO MAINTAIN AN INTERIOR NOISE LEVEL OF 50 DBA.

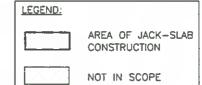
ACCEPTANCE OF BUILDING DESIGN COMPLIANCE WITH THE ABOVE CONDITIONS IS EVIDENCED BY NOTICE TO PROCEED ISSUED BY THE OFFICE OF ENVIRONMENTAL REMEDIATION DATED JUNE 19, 2014 FOR NEW BUILDING APPLICATION NO. 120921002

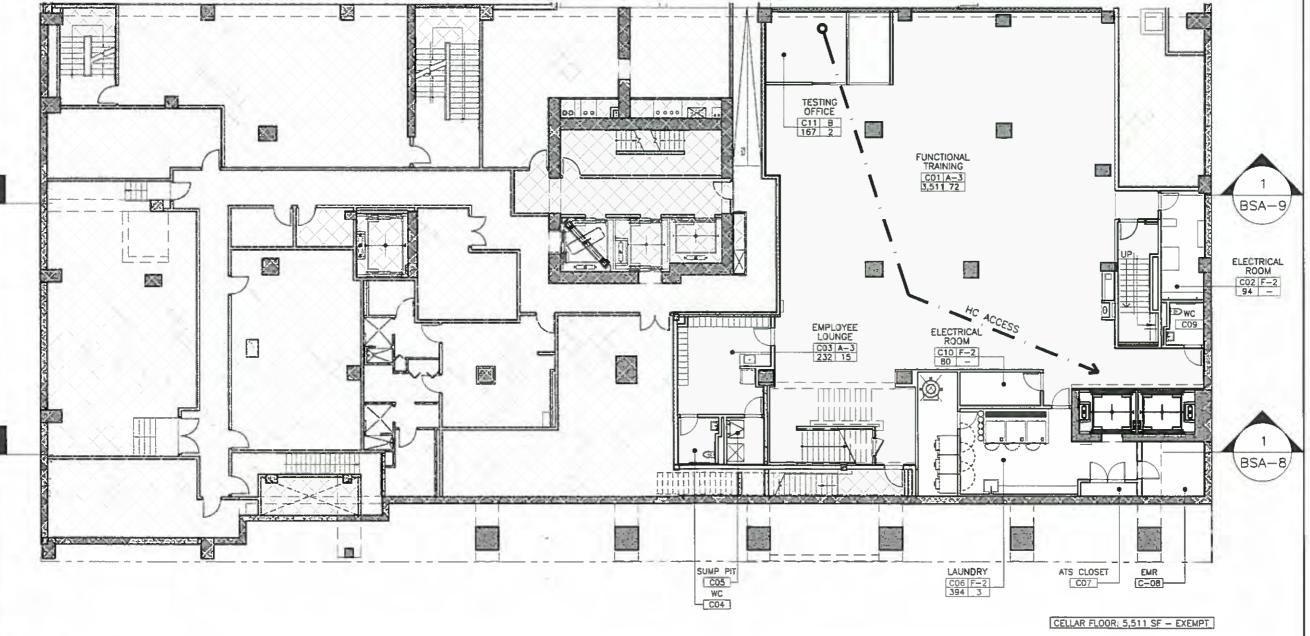
2. NOISE ABATEMENT SHALL BE PROVIDED WITHIN THE PCE SPACE TO ENSURE THAT THE SOUND LEVEL IN OTHER PORTIONS OF THE BUILDING CAUSED BY PCE ACTIVITY DOES NOT EXCEED THE MAXIMUM NOISE LEEL OF 45 DBA. THIS SHALL INCLUDE SOUND EMANATING FROM ANY SOUND

3 FLOORS BENEATH THE PROPOSED STRENGTH AREA, GROUP FITNESS AND CYCLING STUDIO WILL BE 'FLOATING FLOORS' UTILIZING JACK SLAB CONSTRUCTION TO REDUCE VIBRATION TO DEP ACCEPTABLE STANDARDS IN OTHER PORTIONS OF THE BUILDING.

1. INTERIOR LAYOUT AS SHOWN SHALL BE SUBSTANTIALLY COMPLIED WITH, AND ALL EXITS SHALL BE AS APPROVED BY DOB.

2. MAXIMUM OCCUPANT LOAD PER FLOOR/SPACE SHALL BE AS APPROVED





SCALE 1/16" = 1'-0"



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Project

## **EQUINOX** 92ND STREET

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**PROPOSED CELLAR PLAN** 

#### GENERAL NOTES:

- 1 ALL INTERIOR LAYOUTS AND EXITS SHALL BE AS APPROVED BY THE DEPARTMENT OF BUILDINGS.
- 2, MINIMUM 3'-0" WIDE EXIT PATHWAYS SHALL BE APPROVED LEADING TO THE REQUIRED EXITS. PATHWAYS SHALL ALWAYS BE MAINTAINED UNOBSTRUCTED, INCLUDING FROM ANY GYMNASIUM EQUIPMENT.
- 3. AN APPROVED INTERIOR FIRE ALARM SYSTEM SHALL BE INSTALLED IN THE ENTIRE PCE SPACE. THE SYSTEM WILL INCLUDE THE FOLLOWING ITEMS:
  A. AREA SMOKE DETECTORS
  B. MANUAL PULL STATIONS AT EACH REQUIRED EXIT
  C. LOCAL AUDIBLE AND VISUAL ALARMS
  D. CONNECTION OF THE INTERIOR FIRE ALARM TO A FDNY

  - APPROVED CENTRAL STATION
- 4. LOCAL LAW 58-87 SHALL BE COMPLIED WITH AND AS APPROVED BY THE DEPARTMENT OF BUILDINGS.
- 5. PROPOSED SIGNAGE WILL COMPLY WITH APPLICABLE ZONING REGULATIONS.
- 6. FACILITY TO BE EQUIPPED WITH SPRINKLER SYSTEM FILED UNDER A SEPARATE APPLICATION.

NOISE NOTES:

1. THE BUILDING IS SUBJECT TO THE CONDITIONS CONTAINED IN THE CEOR NO. 13DCP 121M REVISED NEGATIVE DECLARATION DATED AUGUST 21, 2013 — IN ORDER TO ENSURE AN ACCEPTABLE INTERIOR NOISE ENVIRONMENT, FUTURE SCHOOL/RESIDENTIAL/COMMERCIAL USES MUST PROVIDE A INTERIOR NOISE ENVIRONMENT, FUTURE SCHOOL/RESIDENTIAL/COMMERCIAL USES MUST PROVIDE A CLOSED WINDOW CONDITION WITH UP TO 41 DBA OF WINDOW/WALL ATTENUATION IN ORDER TO MAINTAIN AN INTERIOR NOISE LEVEL OF 45 DBA\*\*\* IN ORDER TO MAINTAIN A CLOSED WINDOW CONDITION, AN ALTERNATE MEANS OF VENTILATION THAT BRINGS OUTSIDE AIR INTO THE BUILDING, WITHOUT DEGRADING THE ACOUSTICAL PERFORMANCE OF THE BUILDING MUST ALSO BE PROVIDED ALTERNATE MEANS OF VENTILATION INCLUDES, BUT IS NOT LIMITED TO, CENTRAL AIR CONDITIONING, THE SPECIFIC ATTENUATION REQUIREMENTS TO BE IMPLEMENTED THROUGH THE PROJECT BUILDING FACADES ARE PROVIDED IN THE 203—205 EAST 92ND STREET TECHNICAL MEMORANDUM, TABLE 6 (CEQR NO. 13DCP121M), AUGUST 2013.

\*\*\*PER TABLE 6 (CEOR NO. 13DCP121M), AUGUST 2013, THE SUBJECT PCE MUST PROVIDE A CLOSED WINDOW CONDITION, ON THE WEST FACADE ONLY, WITH 32 DBA ON THE 5TH FLOOR AND CLOSED WINDOW CONDITION WITH 30 DBA ON THE 6TH FLOOR IN ORDER TO MAINTAIN AN INTERIOR

ACCEPTANCE OF BUILDING DESIGN COMPLIANCE WITH THE ABOVE CONDITIONS IS EVIDENCED BY NOTICE TO PROCEED ISSUED BY THE OFFICE OF ENVIRONMENTAL REMEDIATION DATED JUNE 19, 2014 FOR NEW BUILDING APPLICATION NO. 120921002.

2. NOISE ABATEMENT SHALL BE PROVIDED WITHIN THE PCE SPACE TO ENSURE THAT THE SOUND LEVEL IN OTHER PORTIONS OF THE BUILDING CAUSED BY PCE ACTIVITY DOES NOT EXCEED THE MAXIMUM NOISE LEEL OF 45 DBA. THIS SHALL INCLUDE SOUND EMANATING FROM ANY SOUND

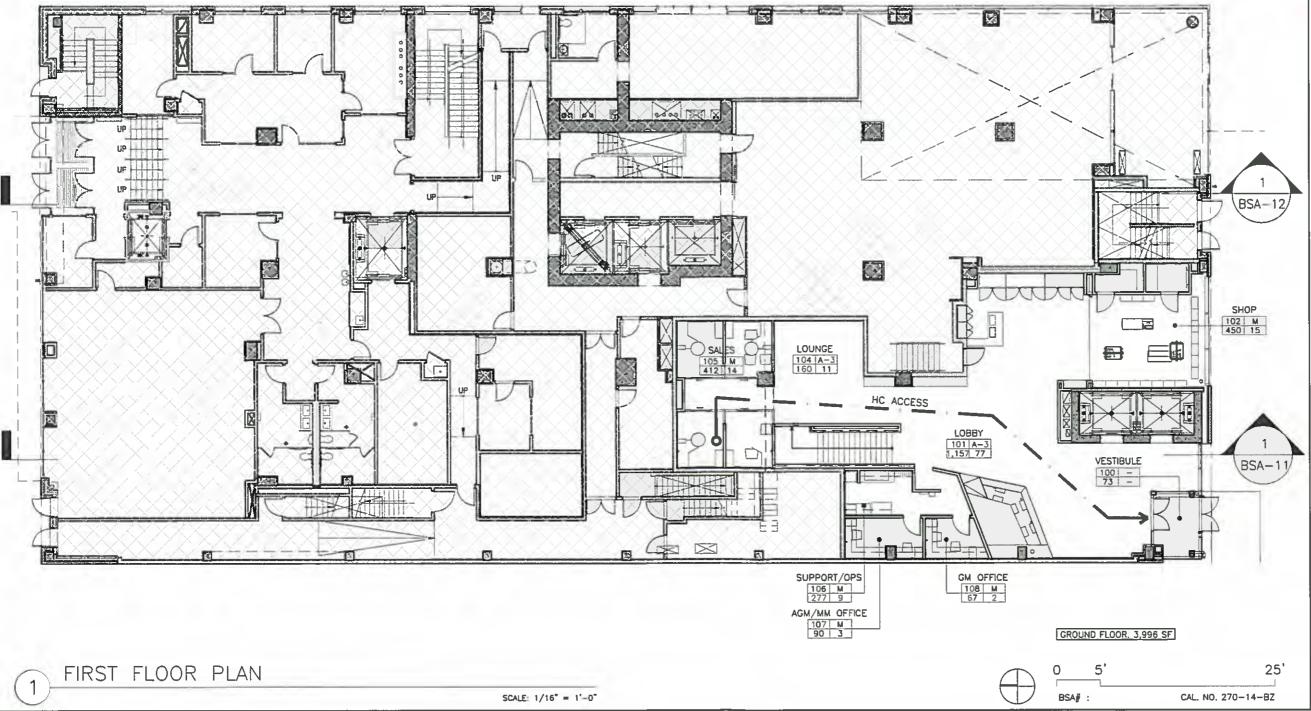
3 FLOORS BENEATH THE PROPOSED STRENGTH AREA, GROUP FITNESS AND CYCLING STUDIO WILL BE 'FLOATING FLOORS' UTILIZING JACK SLAB CONSTRUCTION TO REDUCE VIBRATION TO DEP ACCEPTABLE STANDARDS IN OTHER PORTIONS OF THE BUILDING

NOTE:

1. INTERIOR LAYOUT AS SHOWN SHALL BE SUBSTANTIALLY COMPLIED WITH,
AND ALL EXITS SHALL BE AS APPROVED BY DOB.

2. MAXIMUM OCCUPANT LOAD PER FLOOR/SPACE SHALL BE AS-APPROVED

LEGEND: AREA OF JACK-SLAB CONSTRUCTION NOT N SCOPE



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#### Project **EQUINOX** 92ND STREET

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PROPOSED 1ST **FLOOR PLAN** 

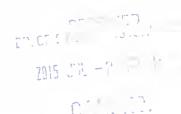
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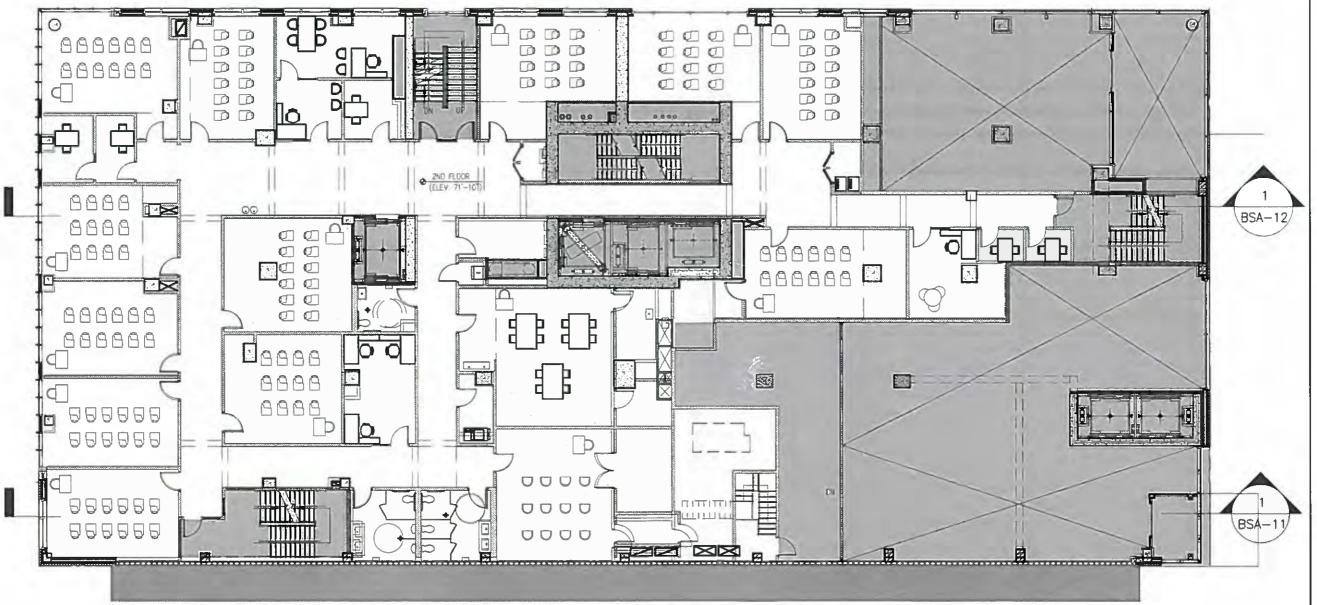
Refer to the Certified Resolution language for the scope and specific distribution of the BSA approval.

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## **EQUINOX** 92ND STREET

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Scale	1/16"=1'-0"
Project no.	13666
Date	07.02.15
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#### PROPOSED 2ND **FLOOR PLAN**

Sheet no.

25'

CAL NO. 270-14-BZ

SIXTH FLOOR: 14,522 SF

BSA#

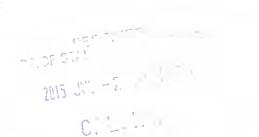
BSA-5

SECOND FLOOR PLAN - SCHOOL

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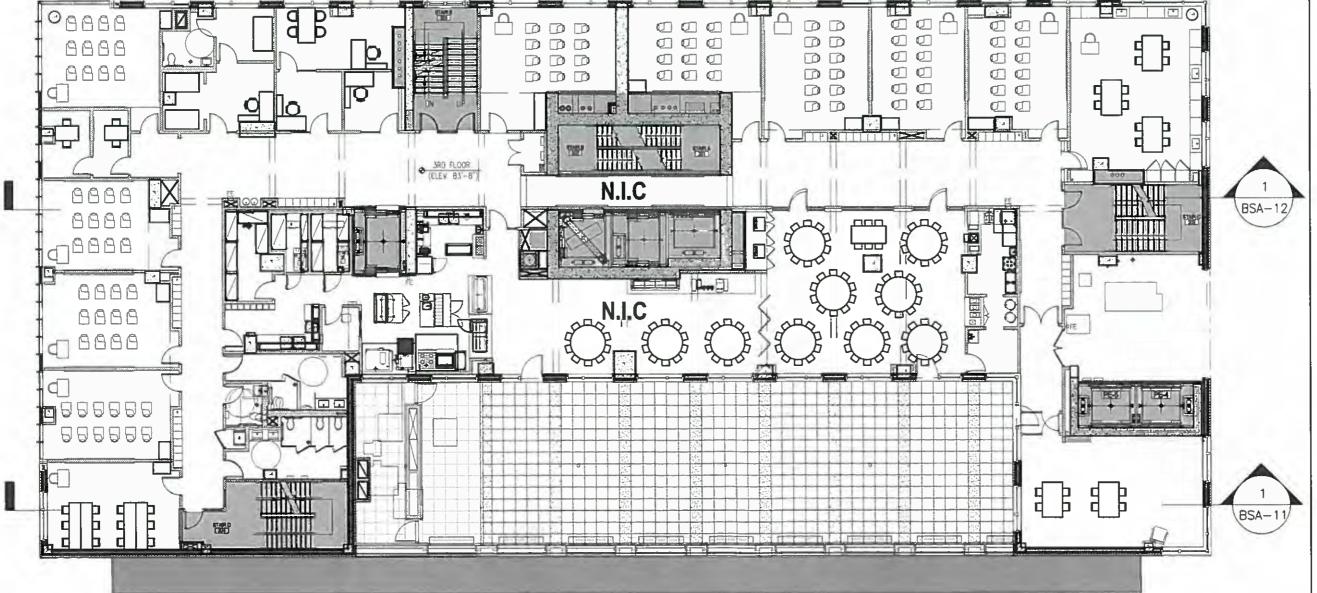
the for the Certified Resolution language for the scope and special coupling of the BSA approval.

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## **EQUINOX** 92ND STREET

Date	07.02.15
Project no.	13666
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Drawn by	TC

Sheet title

#### **PROPOSED 3RD FLOOR PLAN**

Sheet no.

25'

CAL NO. 270-14-BZ

BSA# :

BSA-6

THIRD FLOOR PLAN - SCHOOL

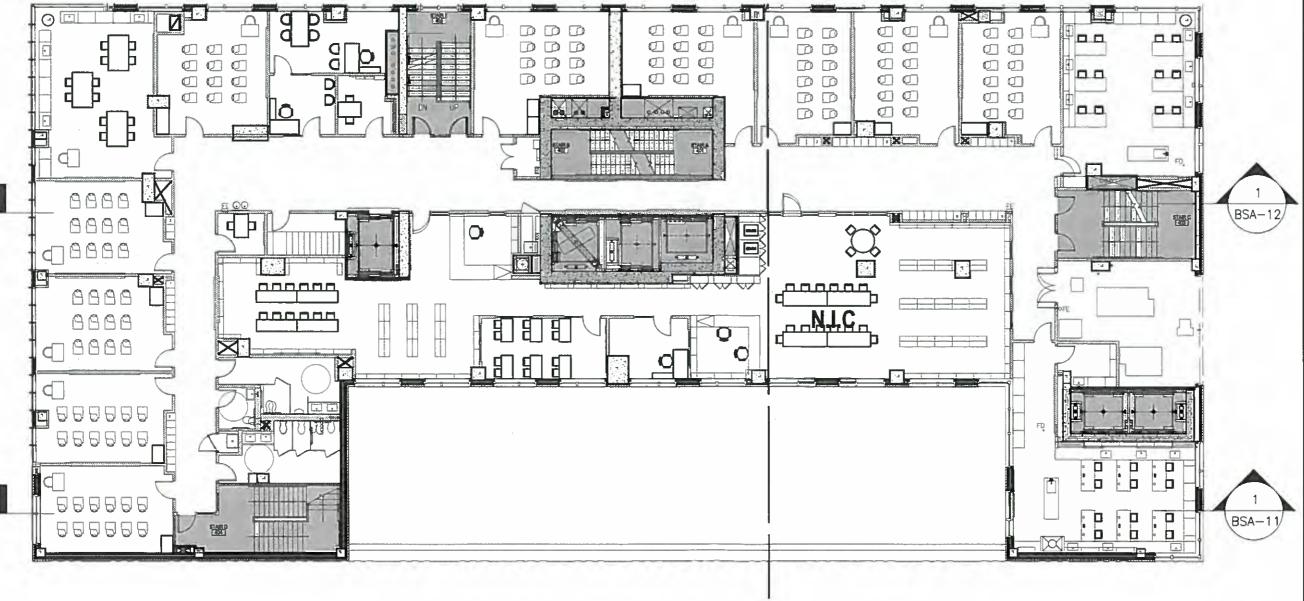
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Project

## **EQUINOX** 92ND STREET

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## **PROPOSED 4TH FLOOR PLAN**

Sheet no.

25'

CAL NO. 270-14-BZ

BSA-7

FOURTH FLOOR PLAN - SCHOOL

#### GENERAL NOTES.

- 1. ALL INTERIOR LAYOUTS AND EXITS SHALL BE AS APPROVED BY THE DEPARTMENT OF BUILDINGS.
- 2, MINIMUM 3'-0" WIDE EXIT PATHWAYS SHALL BE APPROVED LEADING TO THE REQUIRED EXITS. PATHWAYS SHALL ALWAYS BE MAINTAINED UNOBSTRUCTED, INCLUDING FROM ANY GYMNASIUM EQUIPMENT.
- 3. AN APPROVED INTERIOR FIRE ALARM SYSTEM SHALL BE INSTALLED IN THE ENTIRE PCE SPACE. THE SYSTEM WILL INCLUDE THE FOLLOWING ITEMS:
  - A AREA SMOKE DETECTORS
  - MANUAL PULL STATIONS AT EACH REQUIRED EXIT

  - C. LOCAL AUDIBLE AND VISUAL ALARMS
    D. CONNECTION OF THE INTERIOR FIRE ALARM TO A FDNY APPROVED CENTRAL STATION
- 4. LOCAL LAW 58-87 SHALL BE COMPLIED WITH AND AS APPROVED BY THE DEPARTMENT OF BUILDINGS.
- 5. PROPOSED SIGNAGE WILL COMPLY WITH APPLICABLE ZONING REGULATIONS.
- 6. FACILITY TO BE EQUIPPED WITH SPRINKLER SYSTEM FILED UNDER A SEPARATE APPLICATION.

NOISE NOTES:

1. THE BUILDING IS SUBJECT TO THE CONDITIONS CONTAINED IN THE CEOR NO. 13DCP 121M REVISED NEGATIVE DECLARATION DATED AUGUST 21, 2013 — IN ORDER TO ENSURE AN ACCEPTABLE INTERIOR NOISE ENVIRONMENT, FUTURE SCHOOL/RESIDENTIAL/COMMERCIAL USES MUST PROVIDE A CLOSED WINDOW CONDITION WITH UP TO 41 DBA OF WINDOW/WALL ATTENUATION IN ORDER TO MAINTAIN AN INTERIOR NOISE LEVEL OF 45 DBA\*\*\* IN ORDER TO MAINTAIN A CLOSED WINDOW CONDITION, AN ALTERNATE MEANS OF VENTILATION THAT BRINGS OUTSIDE AIR INTO THE BUILDING, WITHOUT DEGRADING THE ACOUSTICAL PERFORMANCE OF THE BUILDING MUST ALSO BE PROVIDED. ALTERNATE MEANS OF VENTILATION INCLUDES, BUT IS NOT LIMITED TO, CENTRAL AIR CONDITIONING. THE SPECIFIC ATTENUATION REQUIREMENTS TO BE IMPLEMENTED THROUGH THE PROJECT BUILDING FACADES ARE PROVIDED IN THE 203-205 EAST 92ND STREET TECHNICAL MEMORANDUM, TABLE 6 (CEQR NO. 13DCP121M), AUGUST 2013.

\*\*\*PER TABLE 6 (CEOR NO. 13DCP121M), AUGUST 2013, THE SUBJECT PCE MUST PROVIDE A CLOSED WINDOW CONDITION, ON THE WEST FACADE ONLY, WITH 32 DBA ON THE 5TH FLOOR AND CLOSED WINDOW CONDITION WITH 30 DBA ON THE 6TH FLOOR IN ORDER TO MAINTAIN AN INTERIOR NOISE LEVEL OF 50 DBA.

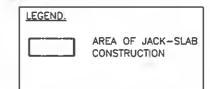
ACCEPTANCE OF BUILDING DESIGN COMPLIANCE WITH THE ABOVE CONDITIONS IS EVIDENCED BY NOTICE TO PROCEED ISSUED BY THE OFFICE OF ENVIRONMENTAL REMEDIATION DATED JUNE 19, 2014 FOR NEW BUILDING APPLICATION NO 120921002

2. NOISE ABATEMENT SHALL BE PROVIDED WITHIN THE PCE SPACE TO ENSURE THAT THE SOUND LEVEL IN OTHER PORTIONS OF THE BUILDING CAUSED BY PCE ACTIVITY DOES NOT EXCEED THE MAXIMUM NOISE LEEL OF 45 DBA. THIS SHALL INCLUDE SOUND EMANATING FROM ANY SOUND SYSTEM, IF INSTALLED.

3. FLOORS BENEATH THE PROPOSED STRENGTH AREA, GROUP FITNESS AND CYCLING STUDIO WILL BE 'FLOATING FLOORS' UTILIZING JACK SLAB CONSTRUCTION TO REDUCE VIBRATION TO DEP ACCEPTABLE STANDARDS IN OTHER PORTIONS OF THE BUILDING.


1. INTERIOR LAYOUT AS SHOWN SHALL BE SUBSTANTIALLY COMPUED WITH, AND ALL EXITS SHALL BE AS APPROVED BY DOB.

2. MAXIMUM OCCUPANT LOAD PER FLOOR/SPACE SHALL BE AS APPROVED



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Project

## **EQUINOX** 92ND STREET

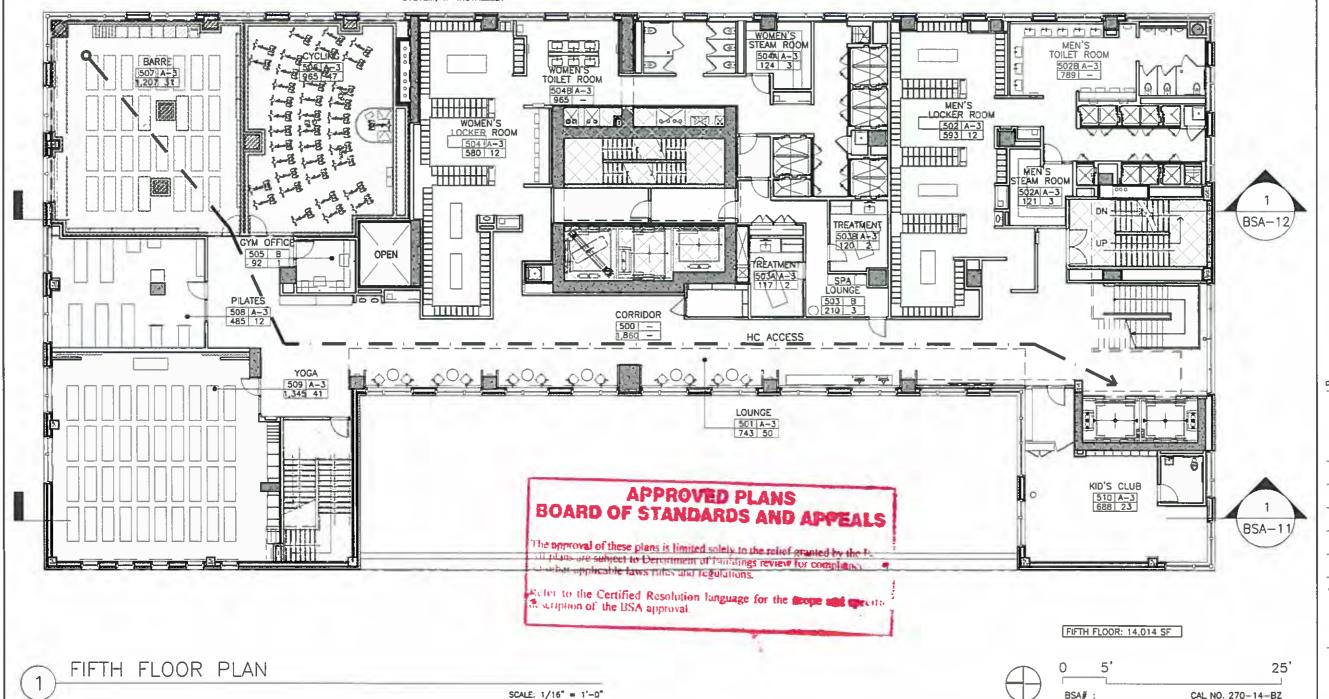Drawn by TC Checked by JS 1/16"=1'-0" Scale Project no. 13666 Date 07.02.15

Sheet title

#### **PROPOSED 5TH FLOOR PLAN**

Sheet no.

#### GENERAL NOTES:

- ALL INTERIOR LAYOUTS AND EXITS SHALL BE AS APPROVED BY THE DEPARTMENT OF BUILDINGS.
- 2, MINIMUM 3'-0" WIDE EXIT PATHWAYS SHALL BE APPROVED LEADING TO THE REQUIRED EXITS. PATHWAYS SHALL ALWAYS BE MAINTAINED UNOBSTRUCTED, INCLUDING FROM ANY GYMNASIUM EQUIPMENT.
- 3. AN APPROVED INTERIOR FIRE ALARM SYSTEM SHALL BE INSTALLED IN THE ENTIRE PCE SPACE. THE SYSTEM WILL INCLUDE THE FOLLOWING ITEMS:

  A. AREA SMOKE DETECTORS
  B. MANUAL PULL STATIONS AT EACH REQUIRED EXIT

  - C. LOCAL AUDIBLE AND VISUAL ALARMS
    D. CONNECTION OF THE INTERIOR FIRE ALARM TO A FDNY APPROVED CENTRAL STATION
- 4. LOCAL LAW 58-87 SHALL BE COMPLIED WITH AND AS APPROVED BY THE DEPARTMENT OF BUILDINGS.
- 5. PROPOSED SIGNAGE WILL COMPLY WITH APPLICABLE ZONING REGULATIONS.
- 6. FACILITY TO BE EQUIPPED WITH SPRINKLER SYSTEM FILED UNDER A SEPARATE APPLICATION.

NOISE NOTES:

1. THE BUILDING IS SUBJECT TO THE CONDITIONS CONTAINED IN THE CEOR NO 13DCP 121M
REVISED NEGATIVE DECLARATION DATED AUGUST 21, 2013 — N ORDER TO ENSURE AN ACCEPTABLE INTERIOR NOISE ENVIRONMENT, FUTURE SCHOOL/RESIDENTIAL/COMMERCIAL USES MUST PROVIDE A CLOSED WINDOW CONDITION WITH UP TO 41 DBA OF WINDOW/WALL ATTENUATION IN ORDER TO MAINTAIN AN INTERIOR NOISE LEVEL OF 45 DBA\*\*. IN ORDER TO MAINTAIN A CLOSED WINDOW MAINTAIN AN INTERIOR NOISE LEVEL OF 45 DBA\*\*. IN ORDER TO MAINTAIN A CLOSED MINDOT CONDITION, AN ALTERNATE MEANS OF VENTILATION THAT BRINGS OUTSIDE AIR INTO THE BUILDING, WITHOUT DEGRADING THE ACOUSTICAL PERFORMANCE OF THE BUILDING MUST ALSO BE PROVIDED. ALTERNATE MEANS OF VENTILATION INCLUDES, BUT IS NOT LIMITED TO, CENTRAL AIR CONDITIONING THE SPECIFIC ATTENUATION REQUIREMENTS TO BE IMPLEMENTED THROUGH THE PROJECT BUILDING FACADES ARE PROVIDED IN THE 203–205 EAST 92ND STREET TECHNICAL MEMORANDUM, TABLE 5 (CEOR NO. 13DCP121M), AUGUST 2013.

\*\*\*PER TABLE 6 (CEQR NO. 13DCP121M), AUGUST 2013, THE SUBJECT PCE MUST PROVIDE A CLOSED WINDOW CONDITION, ON THE WEST FACADE ONLY, WITH 32 DBA ON THE 5TH FLOOR AND CLOSED WINDOW CONDITION WITH 30 DBA ON THE 6TH FLOOR IN ORDER TO MAINTAIN AN INTERIOR NOISE LEVEL OF 50 DBA.

ACCEPTANCE OF BUILDING DESIGN COMPLIANCE WITH THE ABOVE CONDITIONS IS EVIDENCED BY NOTICE TO PROCEED ISSUED BY THE OFFICE OF ENVIRONMENTAL REMEDIATION DATED JUNE 19, 2014 FOR NEW BUILDING APPLICATION NO. 120921002.

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3, FLOORS BENEATH THE PROPOSED STRENGTH AREA, GROUP FITNESS AND CYCUNG STUDIO WILL BE 'FLOATING FLOORS' UTILIZING JACK SLAB CONSTRUCTION TO REDUCE VIBRATION TO DEP ACCEPTABLE STANDARDS IN OTHER PORTIONS OF THE BUILDING.

SIM

1. INTERIOR LAYOUT AS SHOWN SHALL BE SUBSTANTIALLY COMPLIED WITH, AND ALL EXITS SHALL BE AS APPROVED BY DOB.

2 MAXIMUM OCCUPANT LOAD PER FLOOR SPACE SHALL BE AS APPROVED

BY DOB.

LEGEND. AREA OF JACK-SLAB CONSTRUCTION

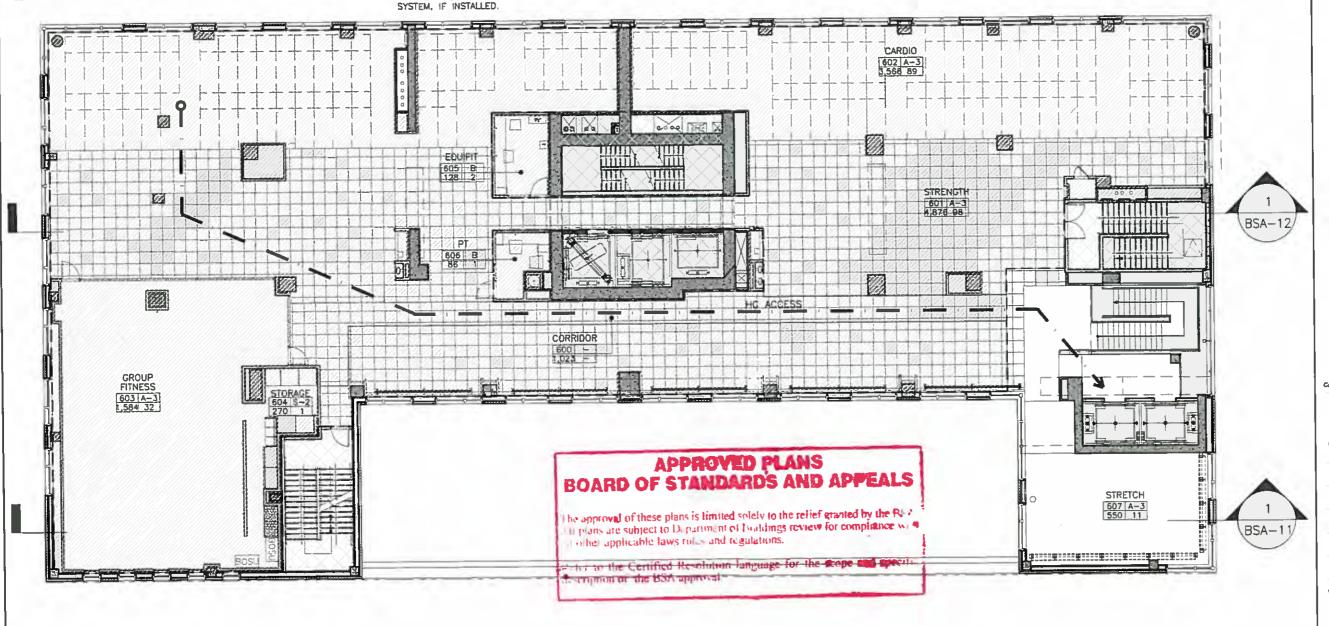
SIXTH FLOOR: 14,522 SF

BSA# :

NOT IN SCOPE

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Project **EQUINOX** 92ND STREET

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Date 07.02.15

Sheet title

PROPOSED 6TH FLOOR PLAN

Sheet no.

25'

CAL NO. 270-14-BZ

BSA-9

SIXTH FLOOR PLAN

#### GENERAL NOTES.

- 1. ALL INTERIOR LAYOUTS AND EXITS SHALL BE AS APPROVED BY THE DEPARTMENT OF BUILDINGS.
- 2, MINIMUM 3'-0" WIDE EXIT PATHWAYS SHALL BE APPROVED LEADING TO THE REQUIRED EXITS. PATHWAYS SHALL ALWAYS BE MAINTAINED UNOBSTRUCTED, INCLUDING FROM ANY GYMNASIUM EQUIPMENT.
- . AN APPROVED INTERIOR FIRE ALARM SYSTEM SHALL BE INSTALLED IN THE ENTIRE PCE SPACE. THE SYSTEM WILL INCLUDE THE FOLLOWING ITEMS
  A. AREA SMOKE DETECTORS

  - B. MANUAL PULL STATIONS AT EACH REQUIRED EXIT C. LOCAL AUDIBLE AND VISUAL ALARMS

  - D. CONNECTION OF THE INTERIOR FIRE ALARM TO A FDNY APPROVED CENTRAL STATION
- 4. LOCAL LAW 58-87 SHALL BE COMPLIED WITH AND AS APPROVED BY THE DEPARTMENT OF BUILDINGS.
- 5. PROPOSED SIGNAGE WILL COMPLY WITH APPLICABLE ZONING REGULATIONS.
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NOISE NOTES:

1. THE BUILDING IS SUBJECT TO THE CONDITIONS CONTAINED IN THE CEOR NO. 13DCP 121M REVISED NEGATIVE DECLARATION DATED AUGUST 21, 2013 — IN ORDER TO ENSURE AN ACCEPTABLE INTERIOR NOISE ENVIRONMENT, FUTURE SCHOOL/RESIDENTIAL/COMMERCIAL USES MUST PROVIDE A CLOSED WINDOW CONDITION WITH UP TO 41 DBA OF WINDOW/WALL ATTENUATION IN ORDER TO MAINTAIN AN INTERIOR NOISE LEVEL OF 45 DBA\*\*\* IN ORDER TO MAINTAIN A CLOSED WINDOW CONDITION, AN ALTERNATE MEANS OF VENTILATION THAT BRINGS OUTSIDE AIR INTO THE BUILDING, WITHOUT DEGRADING THE ACOUSTICAL PERFORMANCE OF THE BUILDING MUST ALSO BE PROVIDED.

ALTERNATE MEANS OF VENTILATION INCLUDES, BUT IS NOT LIMITED TO, CENTRAL AIR CONDITIONING.

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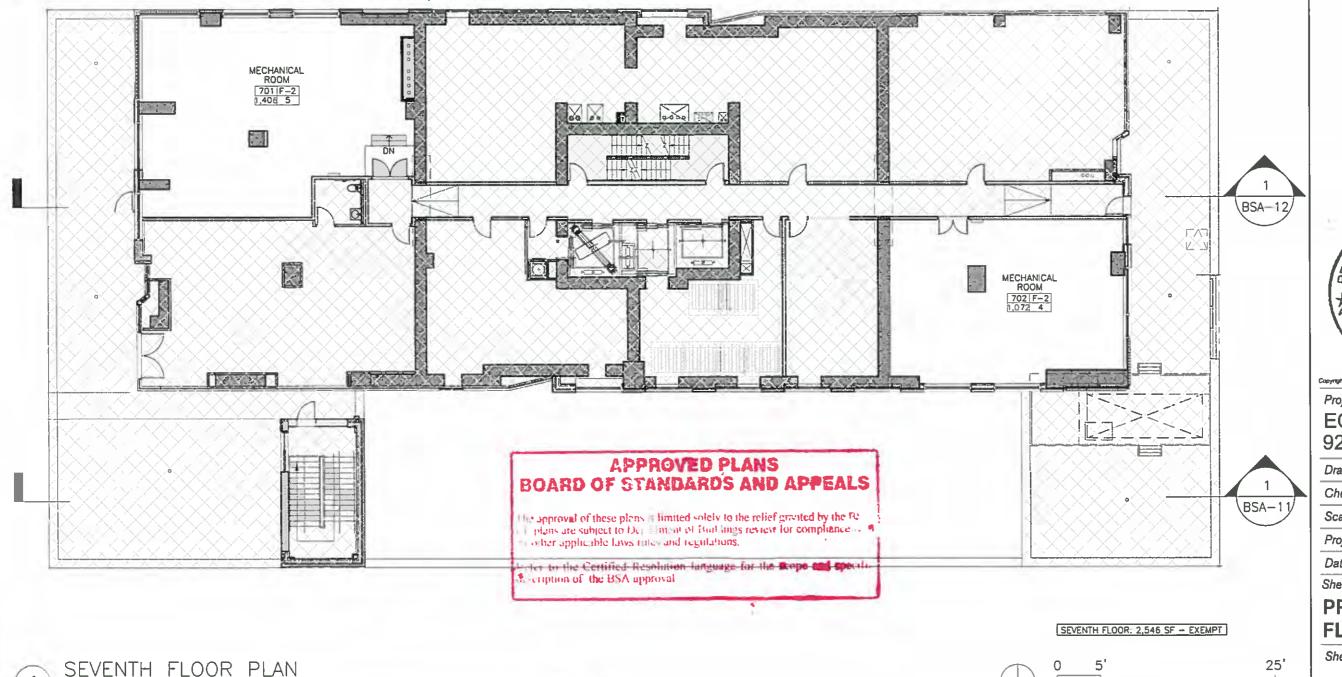
- 1. INTERIOR LAYOUT AS SHOWN SHALL BE SUBSTANTIALLY COMPLIED WITH, AND ALL EXITS SHALL BE AS APPROVED BY DOB.
- 2 MAXIMUM OCCUPANT LOAD PER FLOOR/SPACE SHALL BE AS APPROVED

BSA#

AL. I.V. LEGEND: AREA OF JACK-SLAB CONSTRUCTION NOT IN SCOPE

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SCALE 1/16" = 1'-0"



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Project

**EQUINOX** 92ND STREET

TC Drawn by Checked by JS 1/16"=1'-0" Scale Project no. 13666 Date 07.02.15

Sheet title

PROPOSED 7TH **FLOOR PLAN** 

Sheet no.


CAL NO. 270-14-8Z



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Scale	1/16"=1'-0
Project no.	13666



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SCALE: 1/16" - 1'-0"

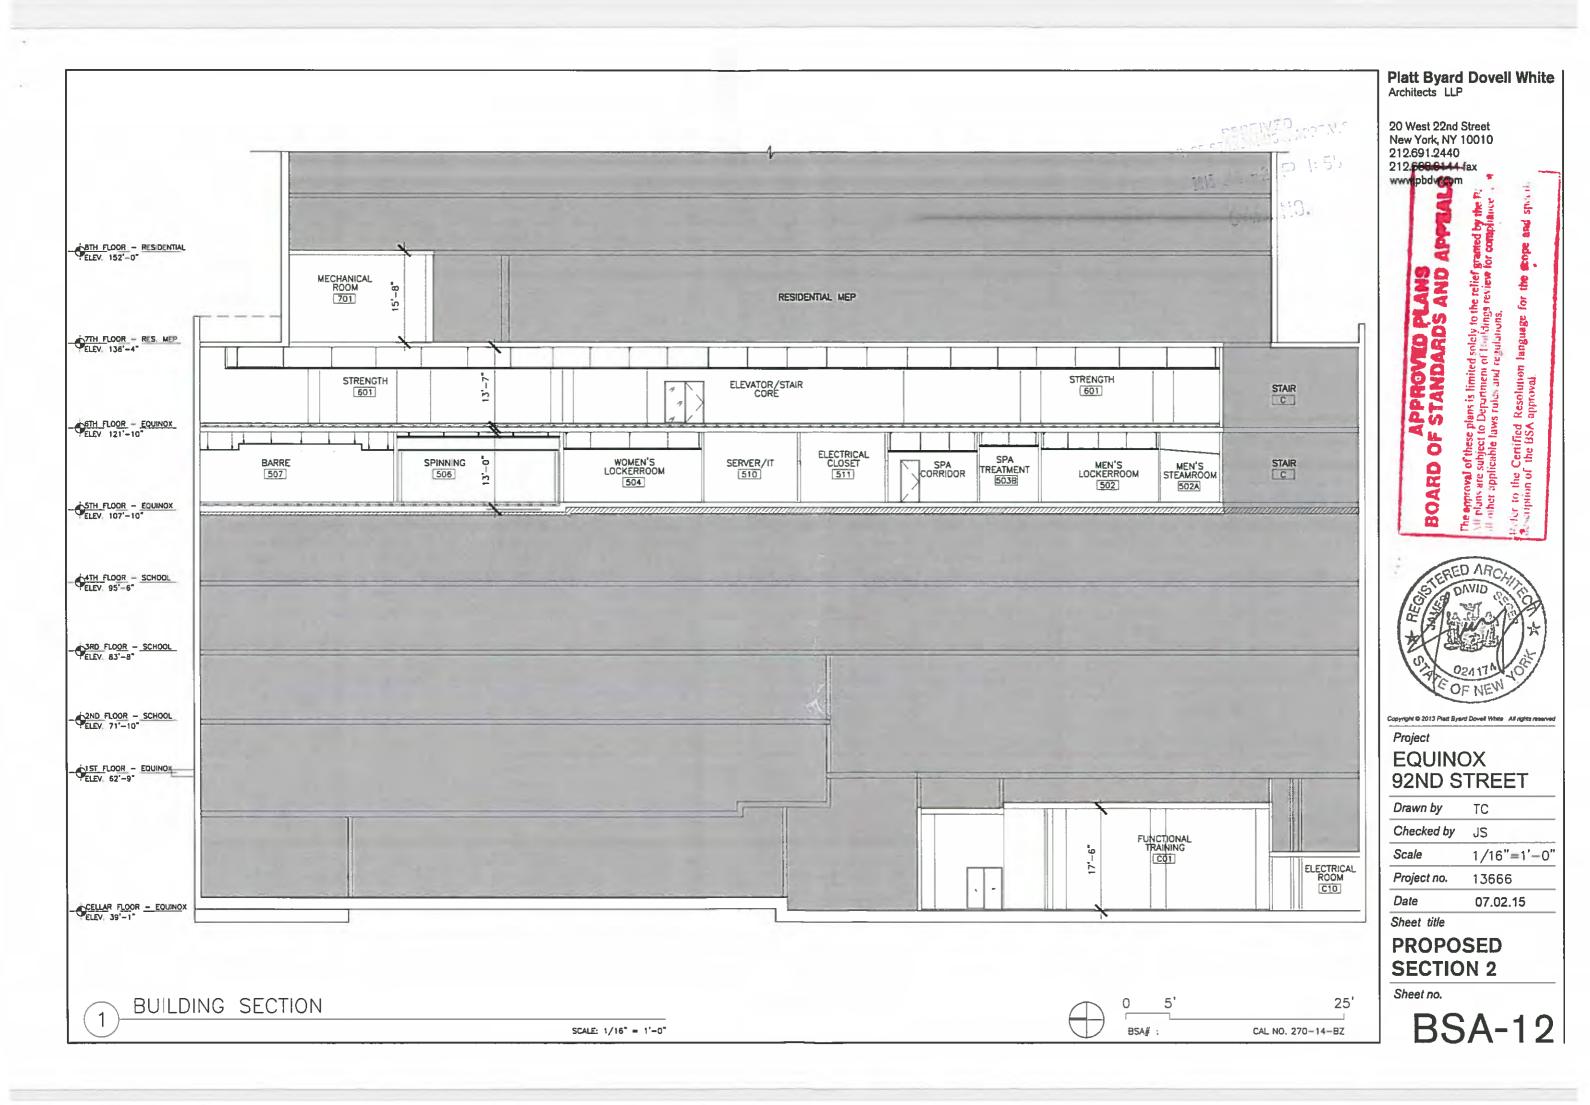**ELEVATION** 



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Project

## EQUINOX 92ND STREET

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Project no. 13666


Date 07.02.15

Sheet title

PROPOSED ELEV - SOUTH

Sheet no.

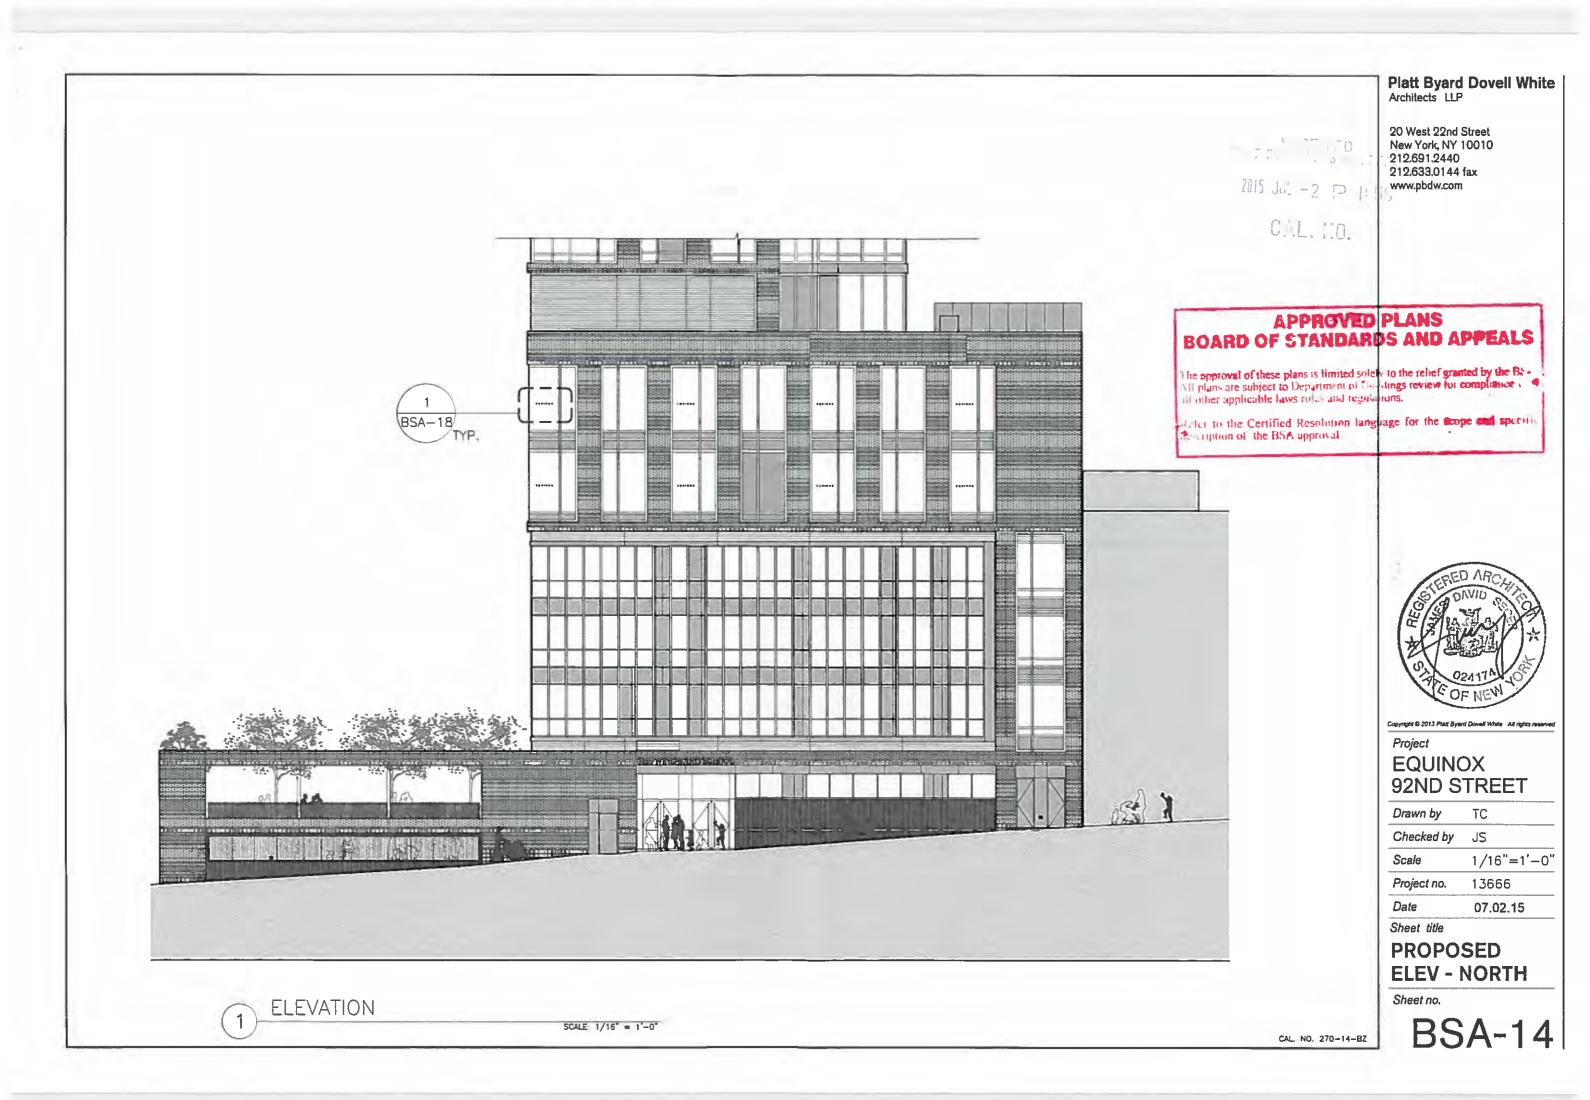CAL. NO. 270-14-BZ





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## EQUINOX 92ND STREET

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Scale 1/16"=1'-0"

Project no. 13666

Date 07.02.15

Sheet title


PROPOSED ELEV - EAST

Sheet no.

**BSA-15** 

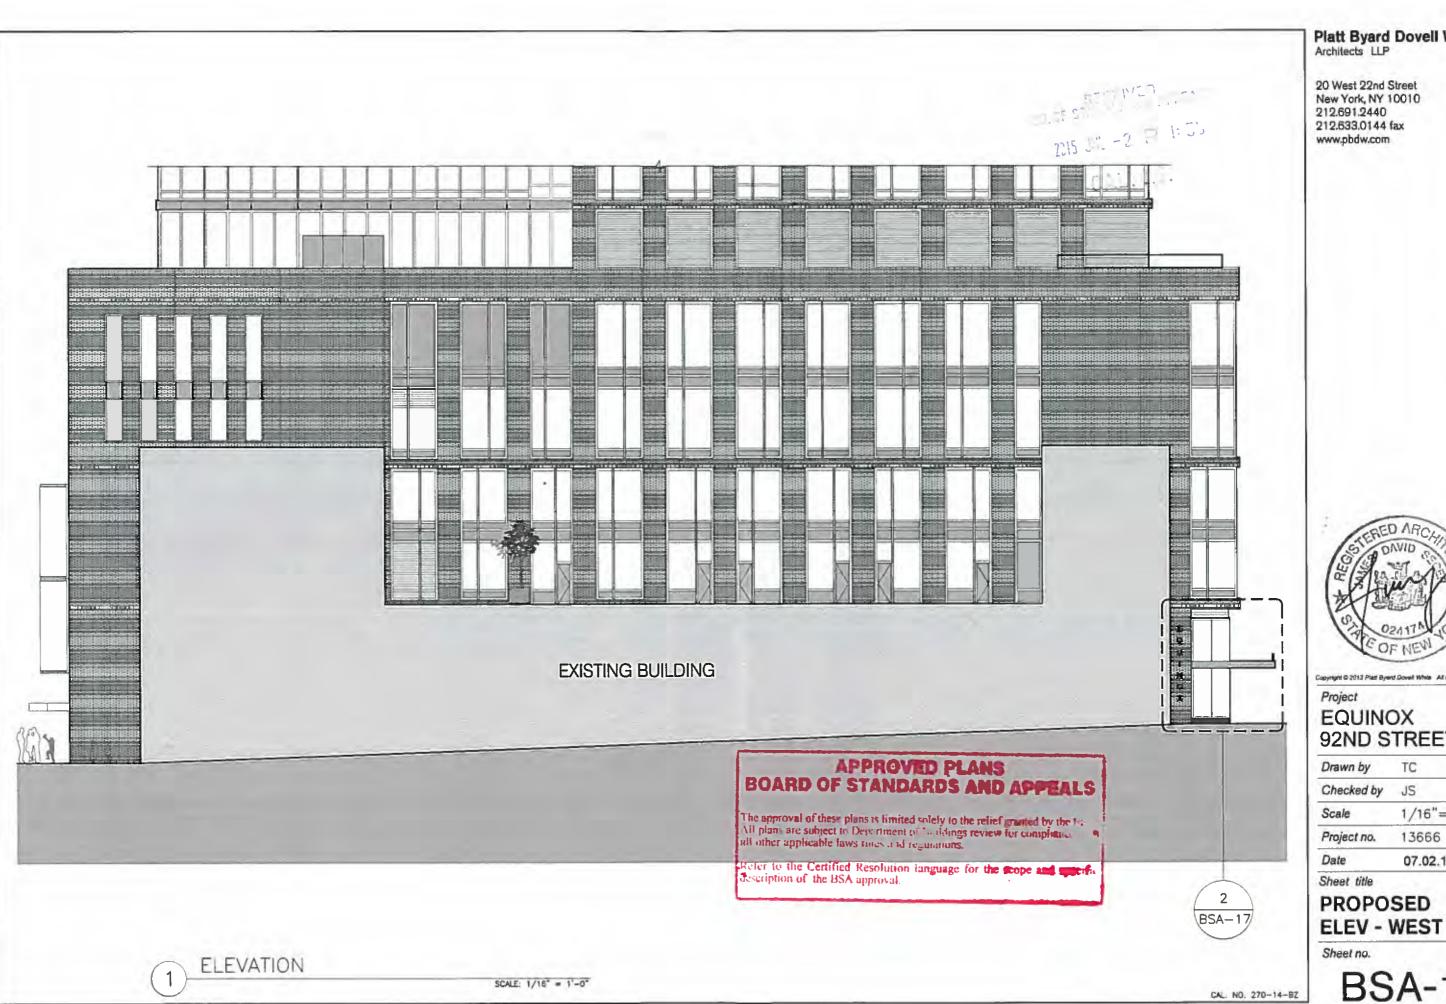The approval of these plans is limited solely to the relief granted by the BS Ali plans are subject to Department of Buildings review for compliance with other applicable laws rules and regulations.

Refer to the Certified Resolution language for the scope and specific



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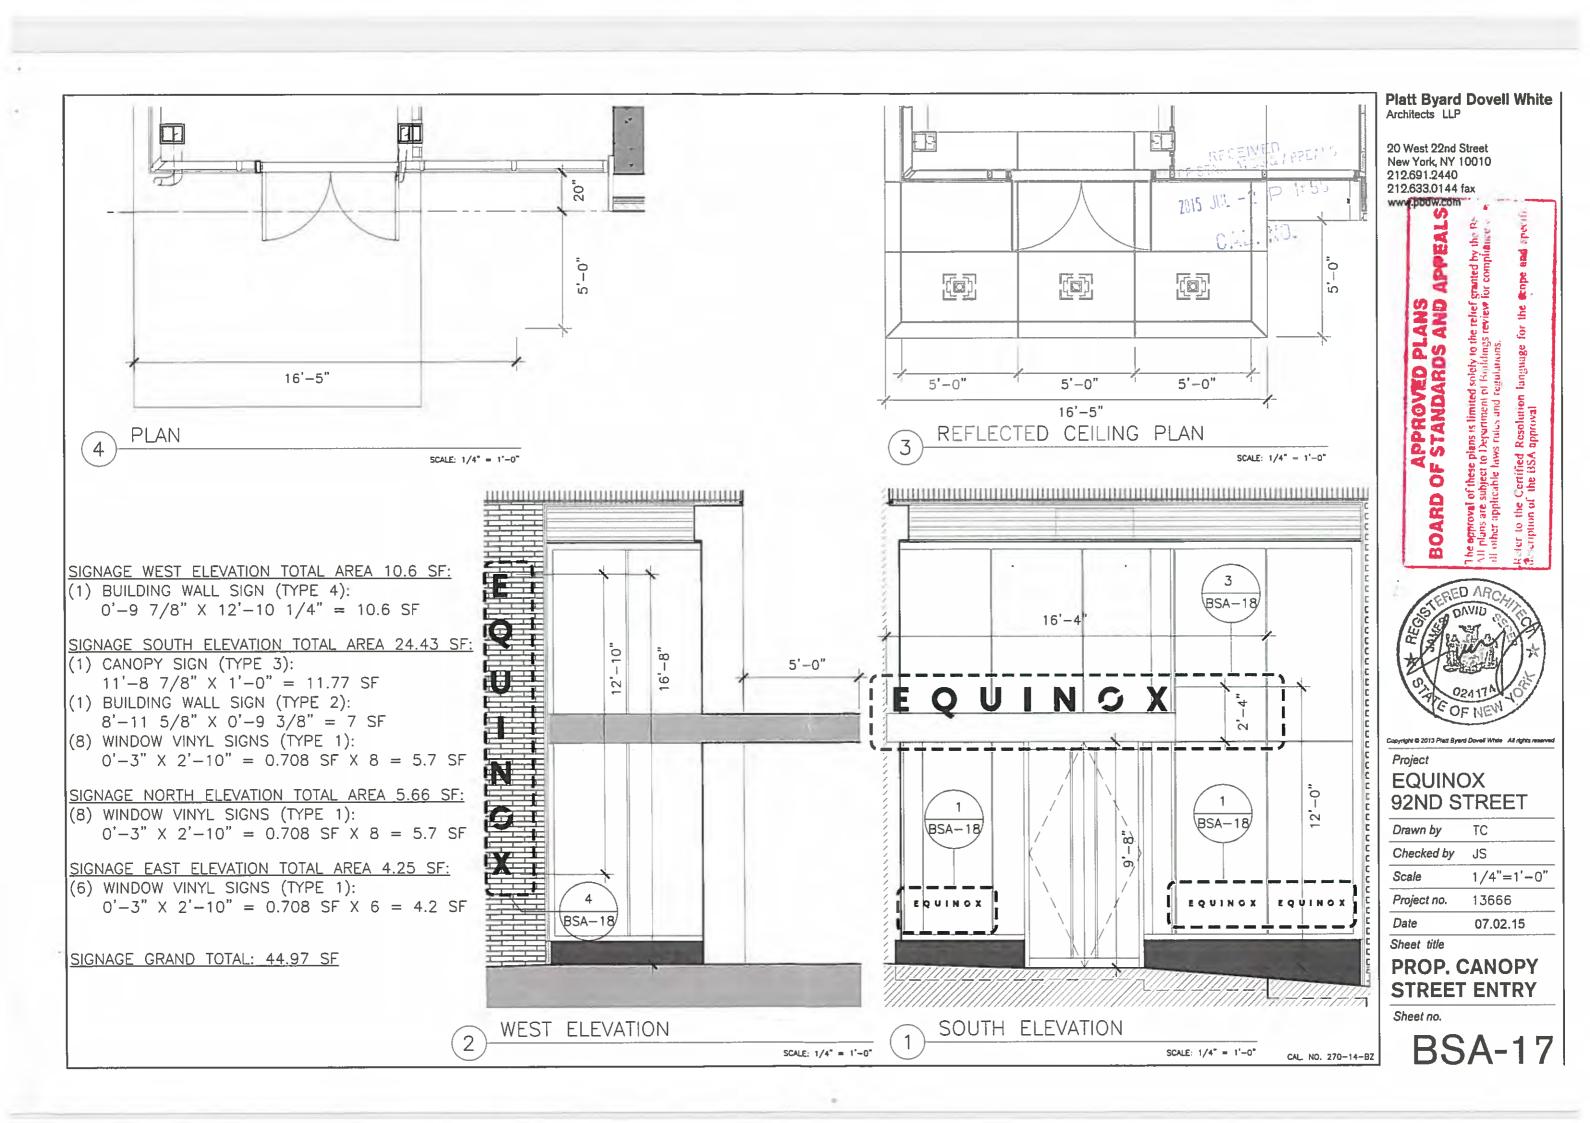
20 West 22nd Street New York, NY 10010 212.691.2440 212.633.0144 fax




## **EQUINOX** 92ND STREET

1	Drawn by	TC
١	Checked by	JS
١	Scale	1/16"=1'-0
١	Project no.	13666
1	Date	07.02.15
- 1		

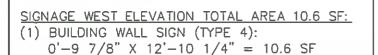**PROPOSED** 





SIGNAGE SOUTH ELEVATION TOTAL AREA 24.43 SF: (1) CANOPY SIGN (TYPE 3):

 $11'-8 7/8" \times 1'-0" = 11.77 SF$ 

(1) BUILDING WALL SIGN (TYPE 2):  $8'-11 5/8" \times 0'-9 3/8" = 7 SF$ 

(8) WINDOW VINYL SIGNS (TYPE 1):  $0'-3" \times 2'-10" = 0.708 \text{ SF } \times 8 = 5.7 \text{ SF}$ 

SIGNAGE NORTH ELEVATION TOTAL AREA 5.66 SF: (8) WINDOW VINYL SIGNS (TYPE 1):

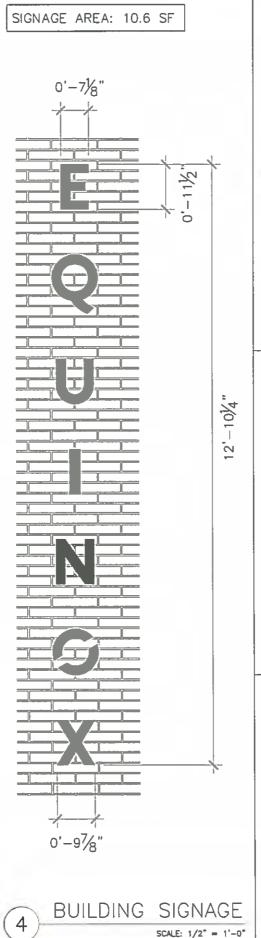
 $0'-3" \times 2'-10" = 0.708 \text{ SF } \times 8 = 5.7 \text{ SF}$ 

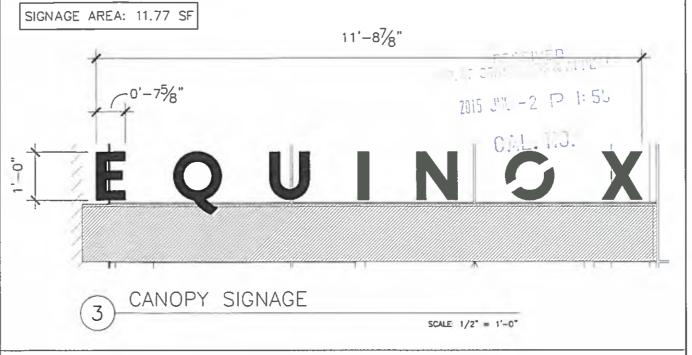
SIGNAGE EAST ELEVATION TOTAL AREA 4.25 SF:

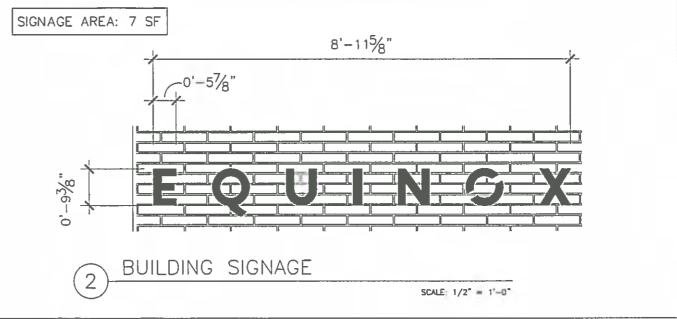
(6) WINDOW VINYL SIGNS (TYPE 1):  $0'-3" \times 2'-10" = 0.708 \text{ SF } \times 6 = 4.2 \text{ SF}$ 

SIGNAGE GRAND TOTAL: 44.97 SF









INDIVIDUAL SIGNAGE AREA: 102 SQ. IN TOTAL NUMBER OF SIGNS: 22 TOTAL SIGNAGE AREA: 15.6 SF



WINDOW SIGNAGE

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**EQUINOX** 92ND STREET

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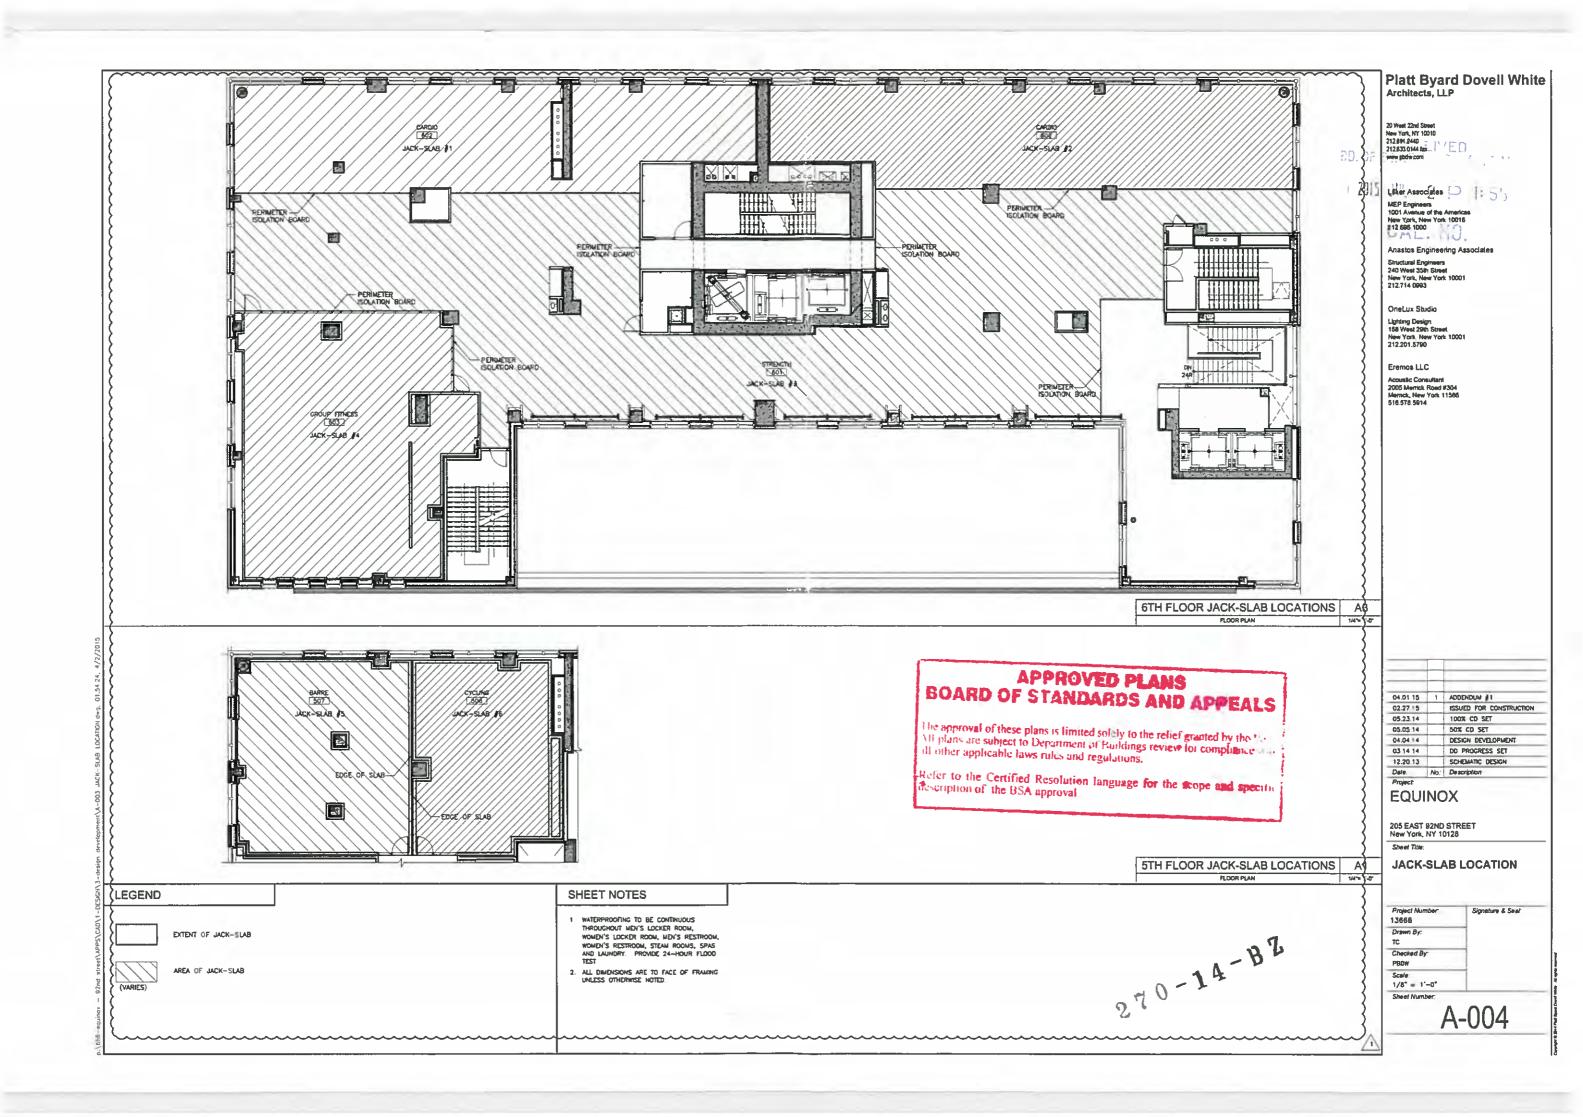
Sheet title

**PROPOSED** SIGNAGE


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CAL. NO. 270-14-BZ

**BSA-18** 



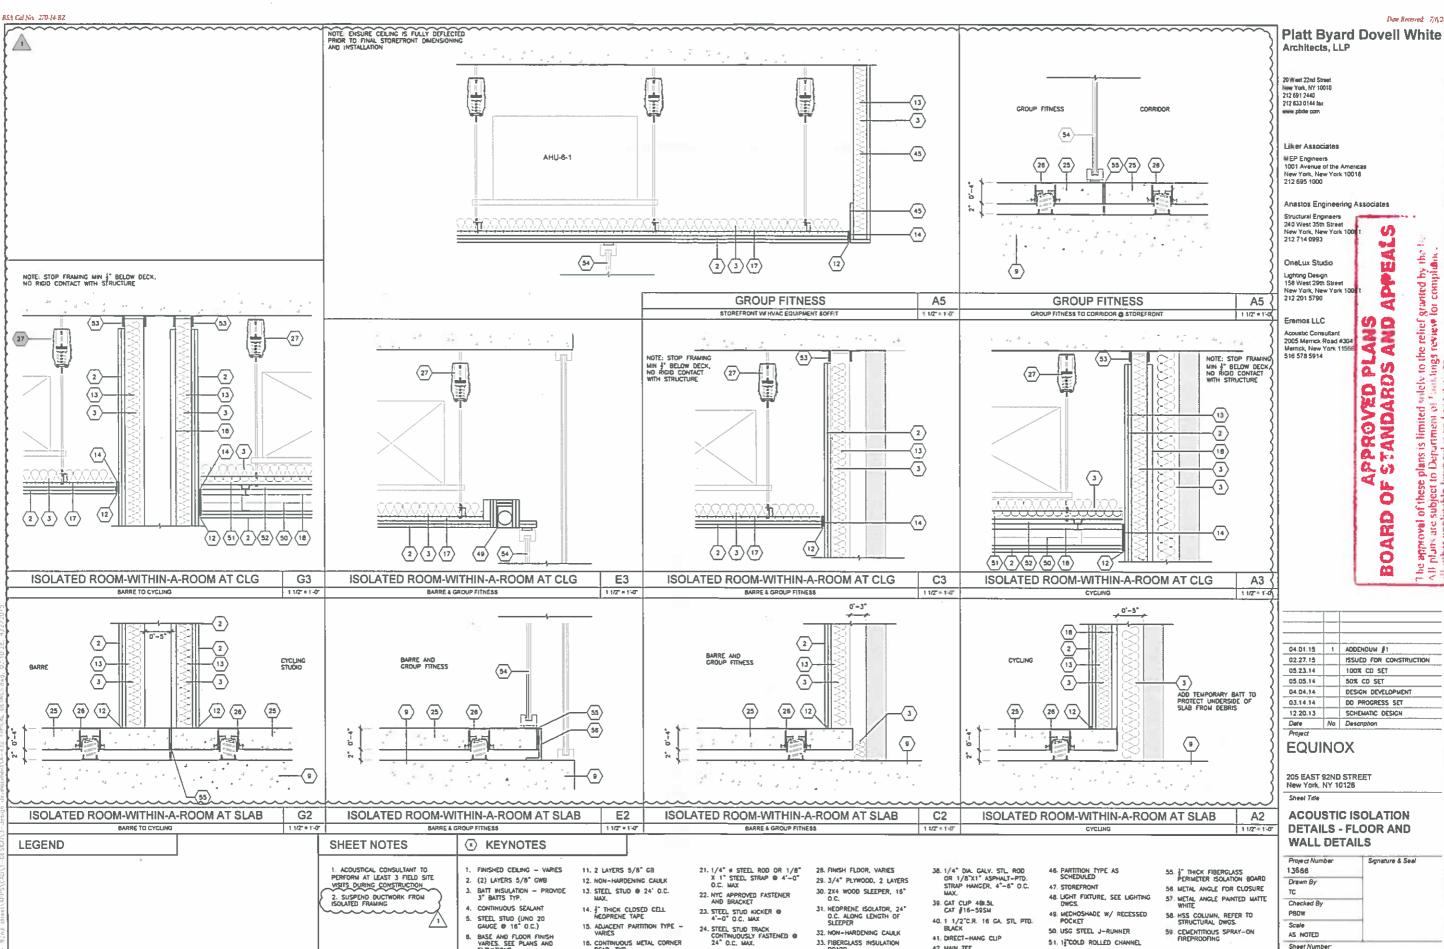Date Received: 7/4/2015



25. 4" ISOLATED SLAB

26. JACK-UP TYPE SPRING ISOLATOR

27. SPRING ISOLATION HANGER -KINETICS NOISE CONTROL MODEL OR MASON

16. CONTINUOUS METAL CORNER
BEAD, TYP.

18. 1' GYPSUM CORE BOARD

20. NYC APPROVED BRACKET

19. 1 1/2" STEEL CHANNEL @ 4"-0" O.C. MAX.

17. FURRING CHANNE L

8. BASE AND FLOOR FINISH VARIES. SEE PLANS AND ELEVATIONS.

8. STEEL HAT CHANNEL @ 24°

10. ACOUSTIC COUNG TILE

7. 5/8" CEMENT BOARD

9. EXISTING SLAB

32. NON-HARDENING CAUL

33. FIBERGLASS INSULATION BOARD

34. 1 5/8" METAL STUD

35. SHEET METAL DUCT

36. APPROVED FASTENER

37 GALV. WIRE SPRING CLIP

41. DIRECT-HANG CLIP

44. 7/8" MTL FURRING C (12" O.C MAX)

45. (1) LAYER 5/8" GWB

42. MAIN TEE

43. WALL ANGLE

51, 1 COLD ROLLED CHANNEL

52. DEYWAL FURRING CHANNEL

33. RESILIENT HEAD RESTRAINT
MASON INDUSTRIES TYPE
AB-716 OR SIMILAR

54. STOREFRONT

A-432

AS NOTED

The approval of these plans is limited solely to the relief granted by the !! All plans are subject to Department of Isan lings review for compliance all other applicable laws rules and regulations.

Refer to the Certified Resolution language for the scope and spe-

BARRE AND SPIN STUDIOS

SLAB DEPRESSION LOCATION

**DEPRESSED SLAB CONDITION** 

(55)

28

KEYNOTES

2. (2) LAYERS 5/8° CWB

4. CONTINUOUS SEALANT

5. STEEL STUD (UNO 20 GAUGE @ 16" O.C.)

6. BASE AND FLOOR FINISH VARIES, SEE PLANS AND ELEVATIONS.

7 5/8" CEMENT BOARD

10. ACOUSTIC CEILING THE

9. EXISTING SLAB

8. STEEL HAT CHANNEL @ 24' O.C.

I. FINISHED CEILING - VARIES

3. BATT INSULATION - PROVIDE 3" BATTS TYP.

EXTERIOR GLAZING -

ISOLATED FLOOR TO EXTERIOR GLAZING

**LEGEND** 

(55)

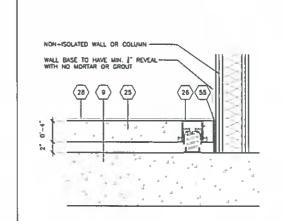
(56)

G2

SHEET NOTES

1 ACOUSTICAL CONSULTANT TO PERFORM AT LEAST 3 FIELD SITE VISITS DURING CONSTRUCTION

(26)



ISOLATED FLOOR TO NON-SOLATED PARTITIONS A42

RAISED FLOOR FOR WATER/TOWEL STATION NON-ISOLATED RAISED FLOOR FCAP BETWEEN TILES 0'-0/4"

(25)

C2 STRENGTH TO NON-ISOLATED RAISED FLOOR 1 1/2 = 1'-0"

40. 1 1/2°C.R. 16 GA. STL PTD. BLACK

CARDIO

35. SHEET METAL DUCT 36. APPROVED FASTENER

28. FINISH FLOOR, VARIES 29. 3/4" PLYWOOD, 2 LAYERS 30. 2X4 WOOD SLEEPER, 16" O.C.

31 NEOPRENE ISOLATOR, 24° O.C. ALONG LENGTH OF SLEEPER 32. NON-HARDENING CAULK 33. FIBERGLASS INSULATION

(55) (26)

(26)

STRENGTH TO CARDIO

21. 1/4" # STEEL ROD OR 1/8" X 1" STEEL STRAP @ 4'-0" O.C. MAX

23. STEEL STUD KICKER @

25. 4" ISOLATED SLAB

26. JACK-UP TYPE SPRING ISOLATOR

24. STEEL STUD TRACK CONTINUOUSLY FASTENED @ 24" O.C. MAX.

34. 1 5/8" METAL STUD

37 GALV. WIRE SPRING CUP

38.1/4° DIA. CALV. STL. ROD OR 1/8"X1" ASPHALT-PTD. STRAP HANGER, 4"-6" O.C. MAX.

41. DIRECT-HANG CLIP 42, MAIN TEE

43. WALL ANGLE 44. 7/8" MTL FURRING CHANNEL (12" D.C MAX) 45. (1) LAYER 5/8" CWB

46. PARTITION TYPE AS SCHEDULED

(26)

(55)

47. STOREFRONT 48. LIGHT FIXTURE, SEE LIGHTING DWGS.

49. MECHOSHADE W/ RECESSED POCKET 50. USG STEEL J-RUNNER

54. STOREFRONT

51 13 COLD ROLLED CHANNEL 52. DRYWAL FURRING CHANNEL

33. RESILIENT HEAD RESTRAIN MASON INDUSTRIES TYPE AB-716 OR SIMILAR

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20 West 22nd Street New York NY 10011 212 691 2440 212 633 0144 fax

Lilker Associates

MEP Engineers 1001 Avenue of the Americas New York, New York 10018 212 695 1000

Anastos Engineering Associates Structural Engineers 240 West 35th Street New York, New York 1000 t 212 714 0993

OneLux Studio

Lighting Design 158 West 29th Street New York, New York 10001 212 201 5790

Eremos LLC

Acoustic Consultant 2005 Merrick Road #304 Merrick, New York 11566 516 578 5914

04.01.15 ADDENDUM #1 ISSUED FOR CONSTRUCTION 02.27.15 100% CD SET 05.23.14 05.05.14 50% CD SET 04.04.14 DESIGN DEVELOPMENT 03.14.14 DO PROGRESS SET SCHEMATIC DESIGN 12.20.13 Date No Description

**EQUINOX** 

205 EAST 92ND STREET New York, NY 10128

A2

11/2" = 1-0"

55. 3" THICK FIBERGLASS
PERIMETER ISOLATION BOARD

56. METAL ANGLE FOR CLOSURE

57 METAL ANGLE PAINTED MATTE

58. HSS COLUMN, REFER TO STRUCTURAL DWGS.

59 CEMENTITIOUS SPRAY-ON FIREPROOFING

**ACOUSTIC ISOLATION DETAILS - FLOOR DETAILS** 

13666 Drawn By Checked By PEDW AS NOTED

A-433

27. SPRING ISOLATION HANGER-KINETICS HOISE CONTROL MODEL OR MASON INDUSTRIES MODEL SON 20. NYC APPROVED BRACKET

STRENGTH

I' ROLLED RUBBER FLOOR @ CARDIO-RUBBER TRANSITION STRIP

1" RUBBER TILE O STRENGTH

(25)

E2

11/2 = 1'-0"

11. 2 LAYERS 5/8" GB

12. NON-HARDENING CAULK

13. STEEL STUD . 24' O.C.

14. 4" THICK CLOSED CELL NEOPRENE TAPE

17, FURRING CHANNE L

15. ADJACENT PARTITION TYPE VARIES

15. CONTINUOUS METAL CORNER BEAD, TYP.

15. 1' GYPSUM CORE BOARD

19. 1 1/2" STEEL CHANNEL & 4"+0" O.C. MAX.

INC MINISTER

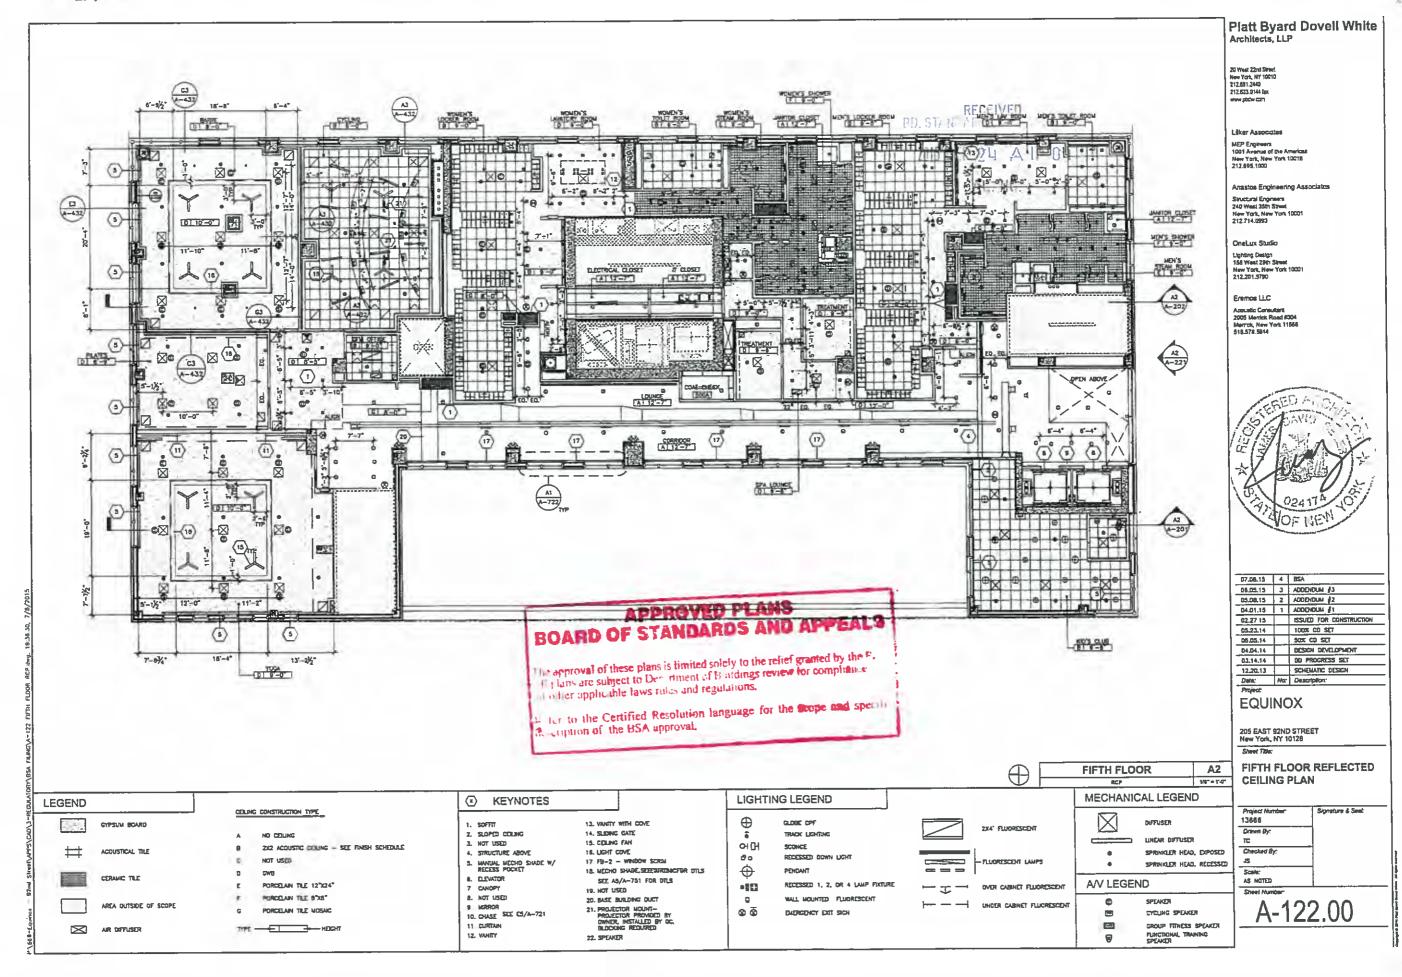
Dan Received: 7/6,2015

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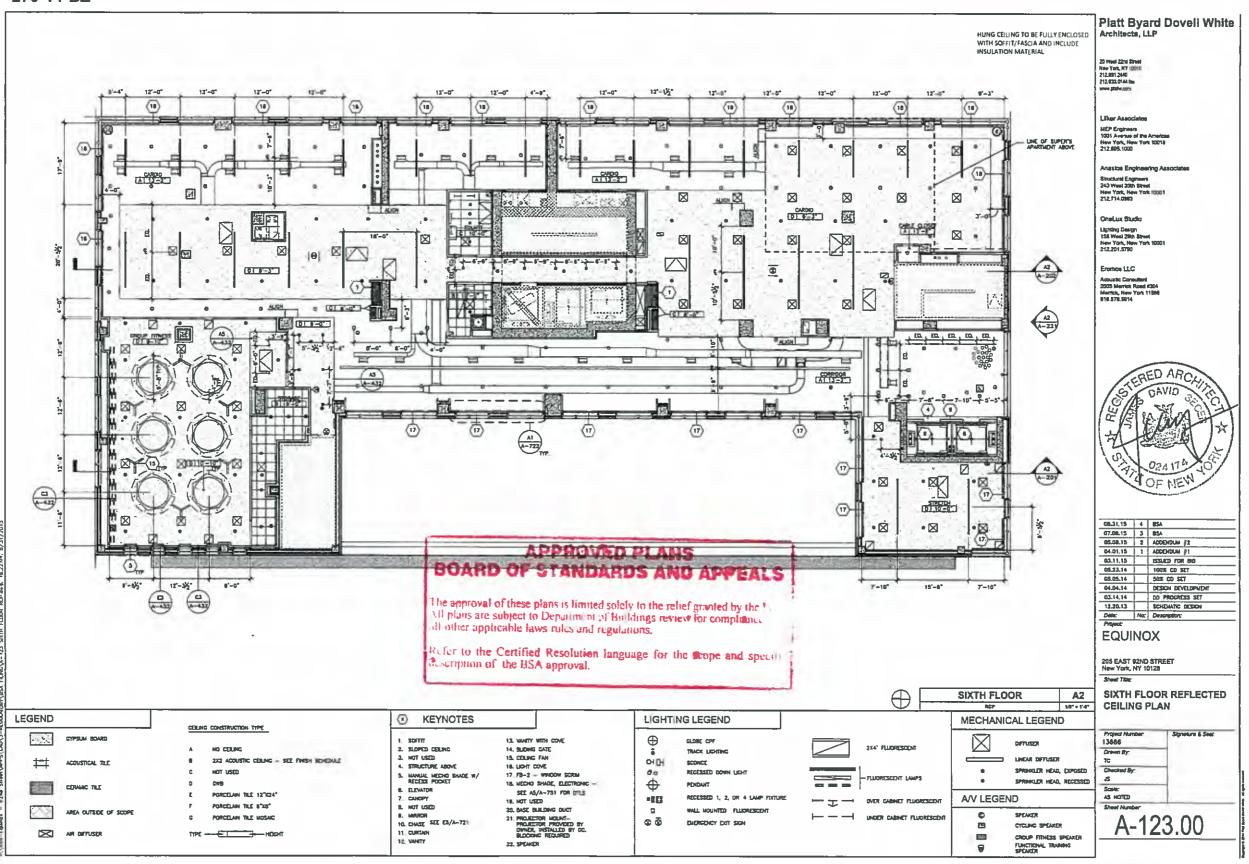
ISSUED FOR CONSTRUCTION

New York City Board of Standards and Appeals

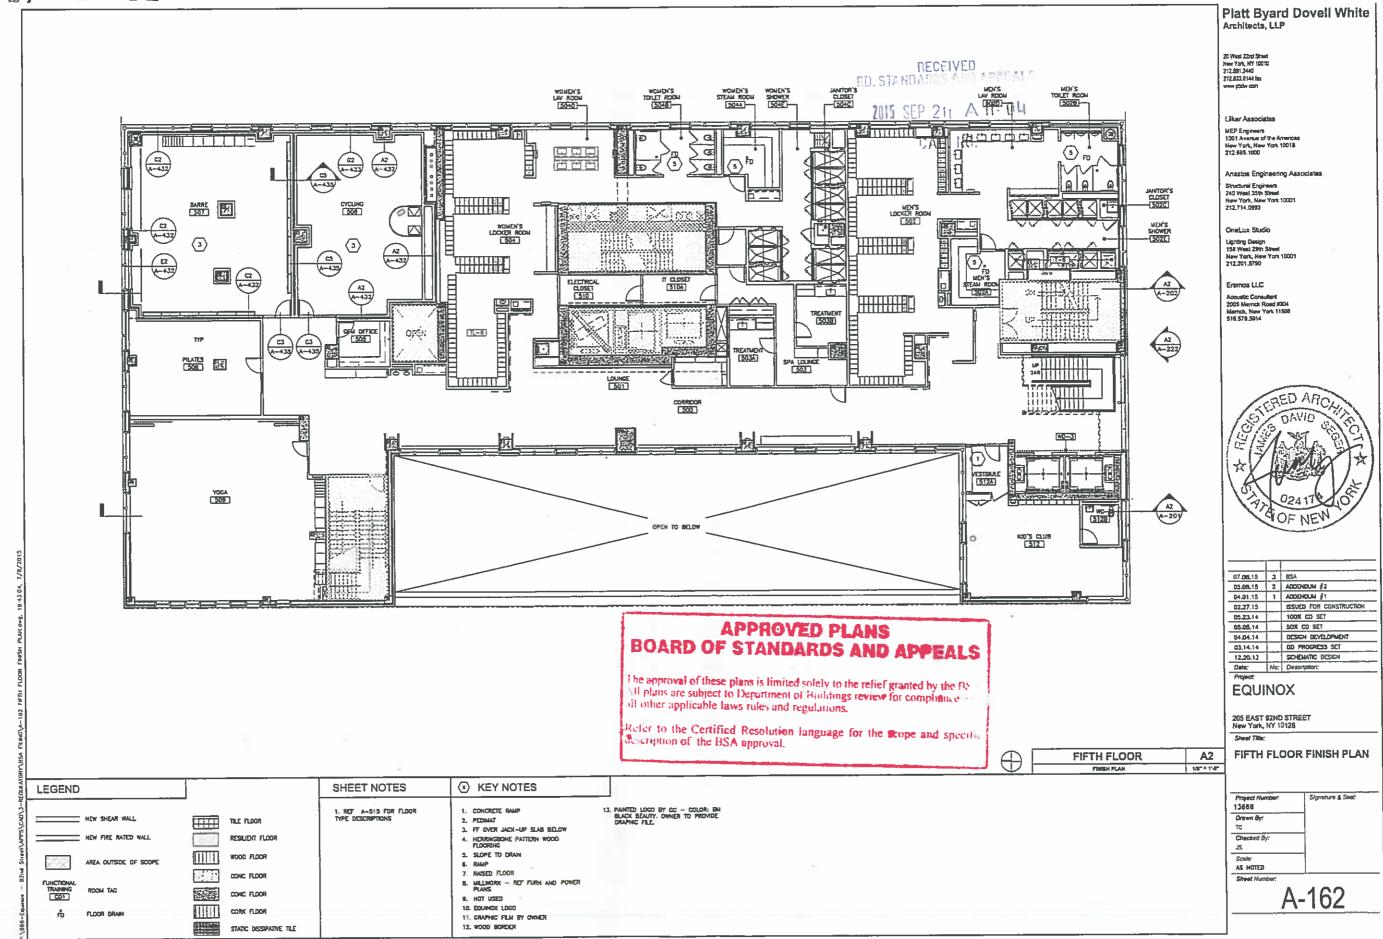
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